
PENNSYLVANIA GAME COMMISSION PROJECT NO. PGC-SCRO-23-01 SOUTHCENTRAL REGIONAL OFFICE NEW 40' X 80' STORAGE BUILDING

SMITHFIELD TOWNSHIP, HUNTINGDON COUNTY, PENNSYLVANIA

CONTRACT NO. 1: GENERAL CONSTRUCTION CONTRACT NO. 2: MECHANICAL CONSTRUCTION CONTRACT NO. 3: PLUMBING CONSTRUCTION CONTRACT NO. 4: ELECTRICAL CONSTRUCTION

SITE PLAN GENERAL NOTES:

- REGARDING LOCATIONS OF UNDERGROUND UTILITIES
- 2. ALL WORK WITHIN THE PUBLIC RIGHT-OF-WAY SHALL BE CONDUCTED IN ACCORDANCE WITH THE REQUIREMENTS OF PENNDOT, THE LOCAL MUNICIPALITY AND THE CONTRACT DOCUMENTS.
- CONTRACTOR SHALL COORDINATE WITH AFFECTED UTILITY COMPANIES IN THE EVENT ITEMS SUCH AS TEMPORARY POLE SUPPORT IS REQUIRED. THIS WORK SHALL BE COMPLETED AT NO ADDITIONAL COST TO THE OWNER.
- 4. EXISTING DRAINAGE FACILITIES SHALL REMAIN INTACT DURING CONSTRUCTION. UNLESS OTHERWISE DIRECTED BY THE ENGINEER.
- 5. ALL AREAS DISTURBED BY THE CONSTRUCTION WORK SHALL BE RESTORED IN ACCORDANCE WITH THE CONTRACT DOCUMENTS TO THEIR ORIGINAL CONDITION OR BETTER.
- 6. ALL DISTURBED AREAS NOT RECEIVING OTHER SURFACE TREATMENT SHALL BE GRADED. SEEDED, AND MULCHED.
- 7. CONTRACTOR SHALL REFER TO CONTRACT DOCUMENTS FOR SOIL EROSION \$ SEDIMENTATION CONTROL PLAN REQUIREMENTS.
- 8. MAINTAIN ACCESS TO DRIVEWAYS AND ENTRANCES LOCATED ALONG THE PROJECT.
- 9. THE CONTRACTOR SHALL ENSURE THAT ALL CONSTRUCTION VEHICLES (INCLUDING MATERIAL SUPPLIER VEHICLES) LEAVING THE PROJECT AREA HAVE MUD BUILDUP REMOVED FROM THE TIRES BEFORE EXITING ONTO PAVED ROADWAYS. ALL MUD TRACKED ONTO PAVED ROADWAYS SHALL BE IMMEDIATELY REMOVED FROM THE ROADWAY.

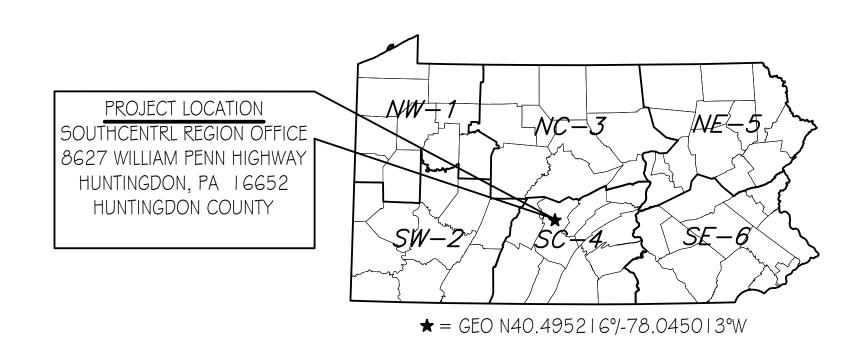

PROJECT LOCATION MAP NO SCALE

BUILDING CODE SUMMARY

Code: International Building Code, 2018 edition

Scope: Construction of a new 40' x 80' Storage Building for the Southeast Regional Office in Maidencreek Township, Berks County. The new building shall include accommodations for PGC staff and storage of equipment and material to complete research on wildlife species

304. I B Building occupied portion for Office 3.11.1 S-1, Building portion used for Storage

VB (Table 601) Construction Type: New Building Area: 3,200 s.f. 9.000 s.f. (Table 506.2) Allowable Area:

I Story, No basement, Allowable Stories: I Table 504.4) Building Stories:

No fire suppression, not required. Fire Protection: Units of "A" = $3,200 / 1,500 = 2.13 \sim 3$ (Table 906.3(1)) Fire Fire Extinguishers: extinguisher shall be provided at each of the two building exits and one

at the opposite end of building near OH door. Buisness, Occupancy Factor = 150 gross

Occupant Load: $552 \, \text{S.F./I} \, 50 = 3.68 \sim 4 \, \text{persons}$ Storage, Occupancy Factor = 300 gross

 $2.648 \text{ S.F./300} = 8.82 \sim 9 \text{ persons}$ 13×0.2 inches = 2.6 inches min. (1005.3.2). Egress Width:


3 Exits provided = 114 inches; 1 required (Table 1006.3.3(2)) Means Of Egress: All building features shall be fully ADA complaint in accordance with the Accessibility: 2018 IBC Chapters 11- Accessibility and ICC A117.1-2017. Building to be fully heated and air conditioned. Building envelope, HVAC Energy Efficiency:

system and lighting systems shall comply with all International Conservation Code (ICC) applicable provisions.

2018- IPC Chapter 4 Fixtures, Faucets and Fixture Fittings Plumbing Fixture(s): Section 403.2, Seperate Facilities (Exceptions 2) - Seperate

Facilities not required.

Section 410.2, Drinking Fountains Small Occupancies - Drinking Fountain

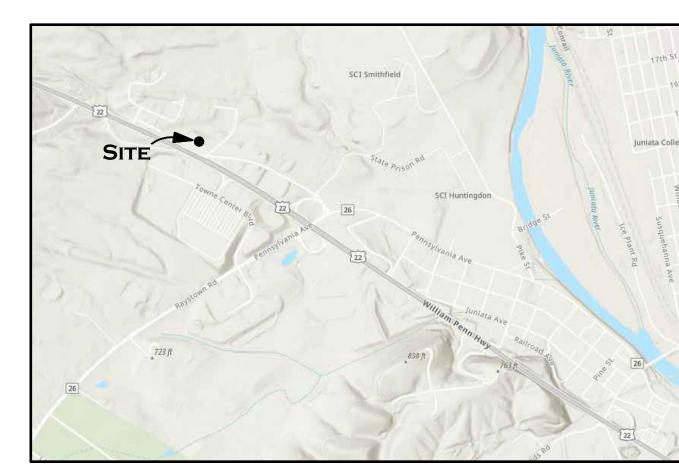

PROJECT VICINITY MAP NOT TO SCALE

DRAWING INDEX

CS-I COVER SHEET

SP-I EXISTING BUILDING SITE PLAN

SP-2 BUILDING SITE PLAN & DETAILS A-I BUILDING FLOOR PLAN & DETAILS

A-2 ELEVATIONS, SECTIONS, SCHEDULES & REFLECTED CEILING PLAN

A-3 WALL SECTION & DETAILS

A-4 WALL SECTION & DETAILS

A-5 ENLARGED PLAN & ELEVATIONS

P-I PLUMBING FLOOR PLAN, ELEVATIONS \$ DETAILS

MECHANICAL FLOOR PLAN & DETAILS E-I ELECTRICAL FLOOR PLAN, SCHEDULES & DETAILS




PENNSYLVANIA GAME COMMISSION SOUTHCENTRAL REGIONAL OFFICE | SMITHFIELD TOWNSHIP | HUNTINGDON COUNT NEW 40' x 80' STORAGE BUILDING COVER SHEET REVISIONS PROJECT NO. SCRO-23-01 DRAWN BY: M. SPOTTS


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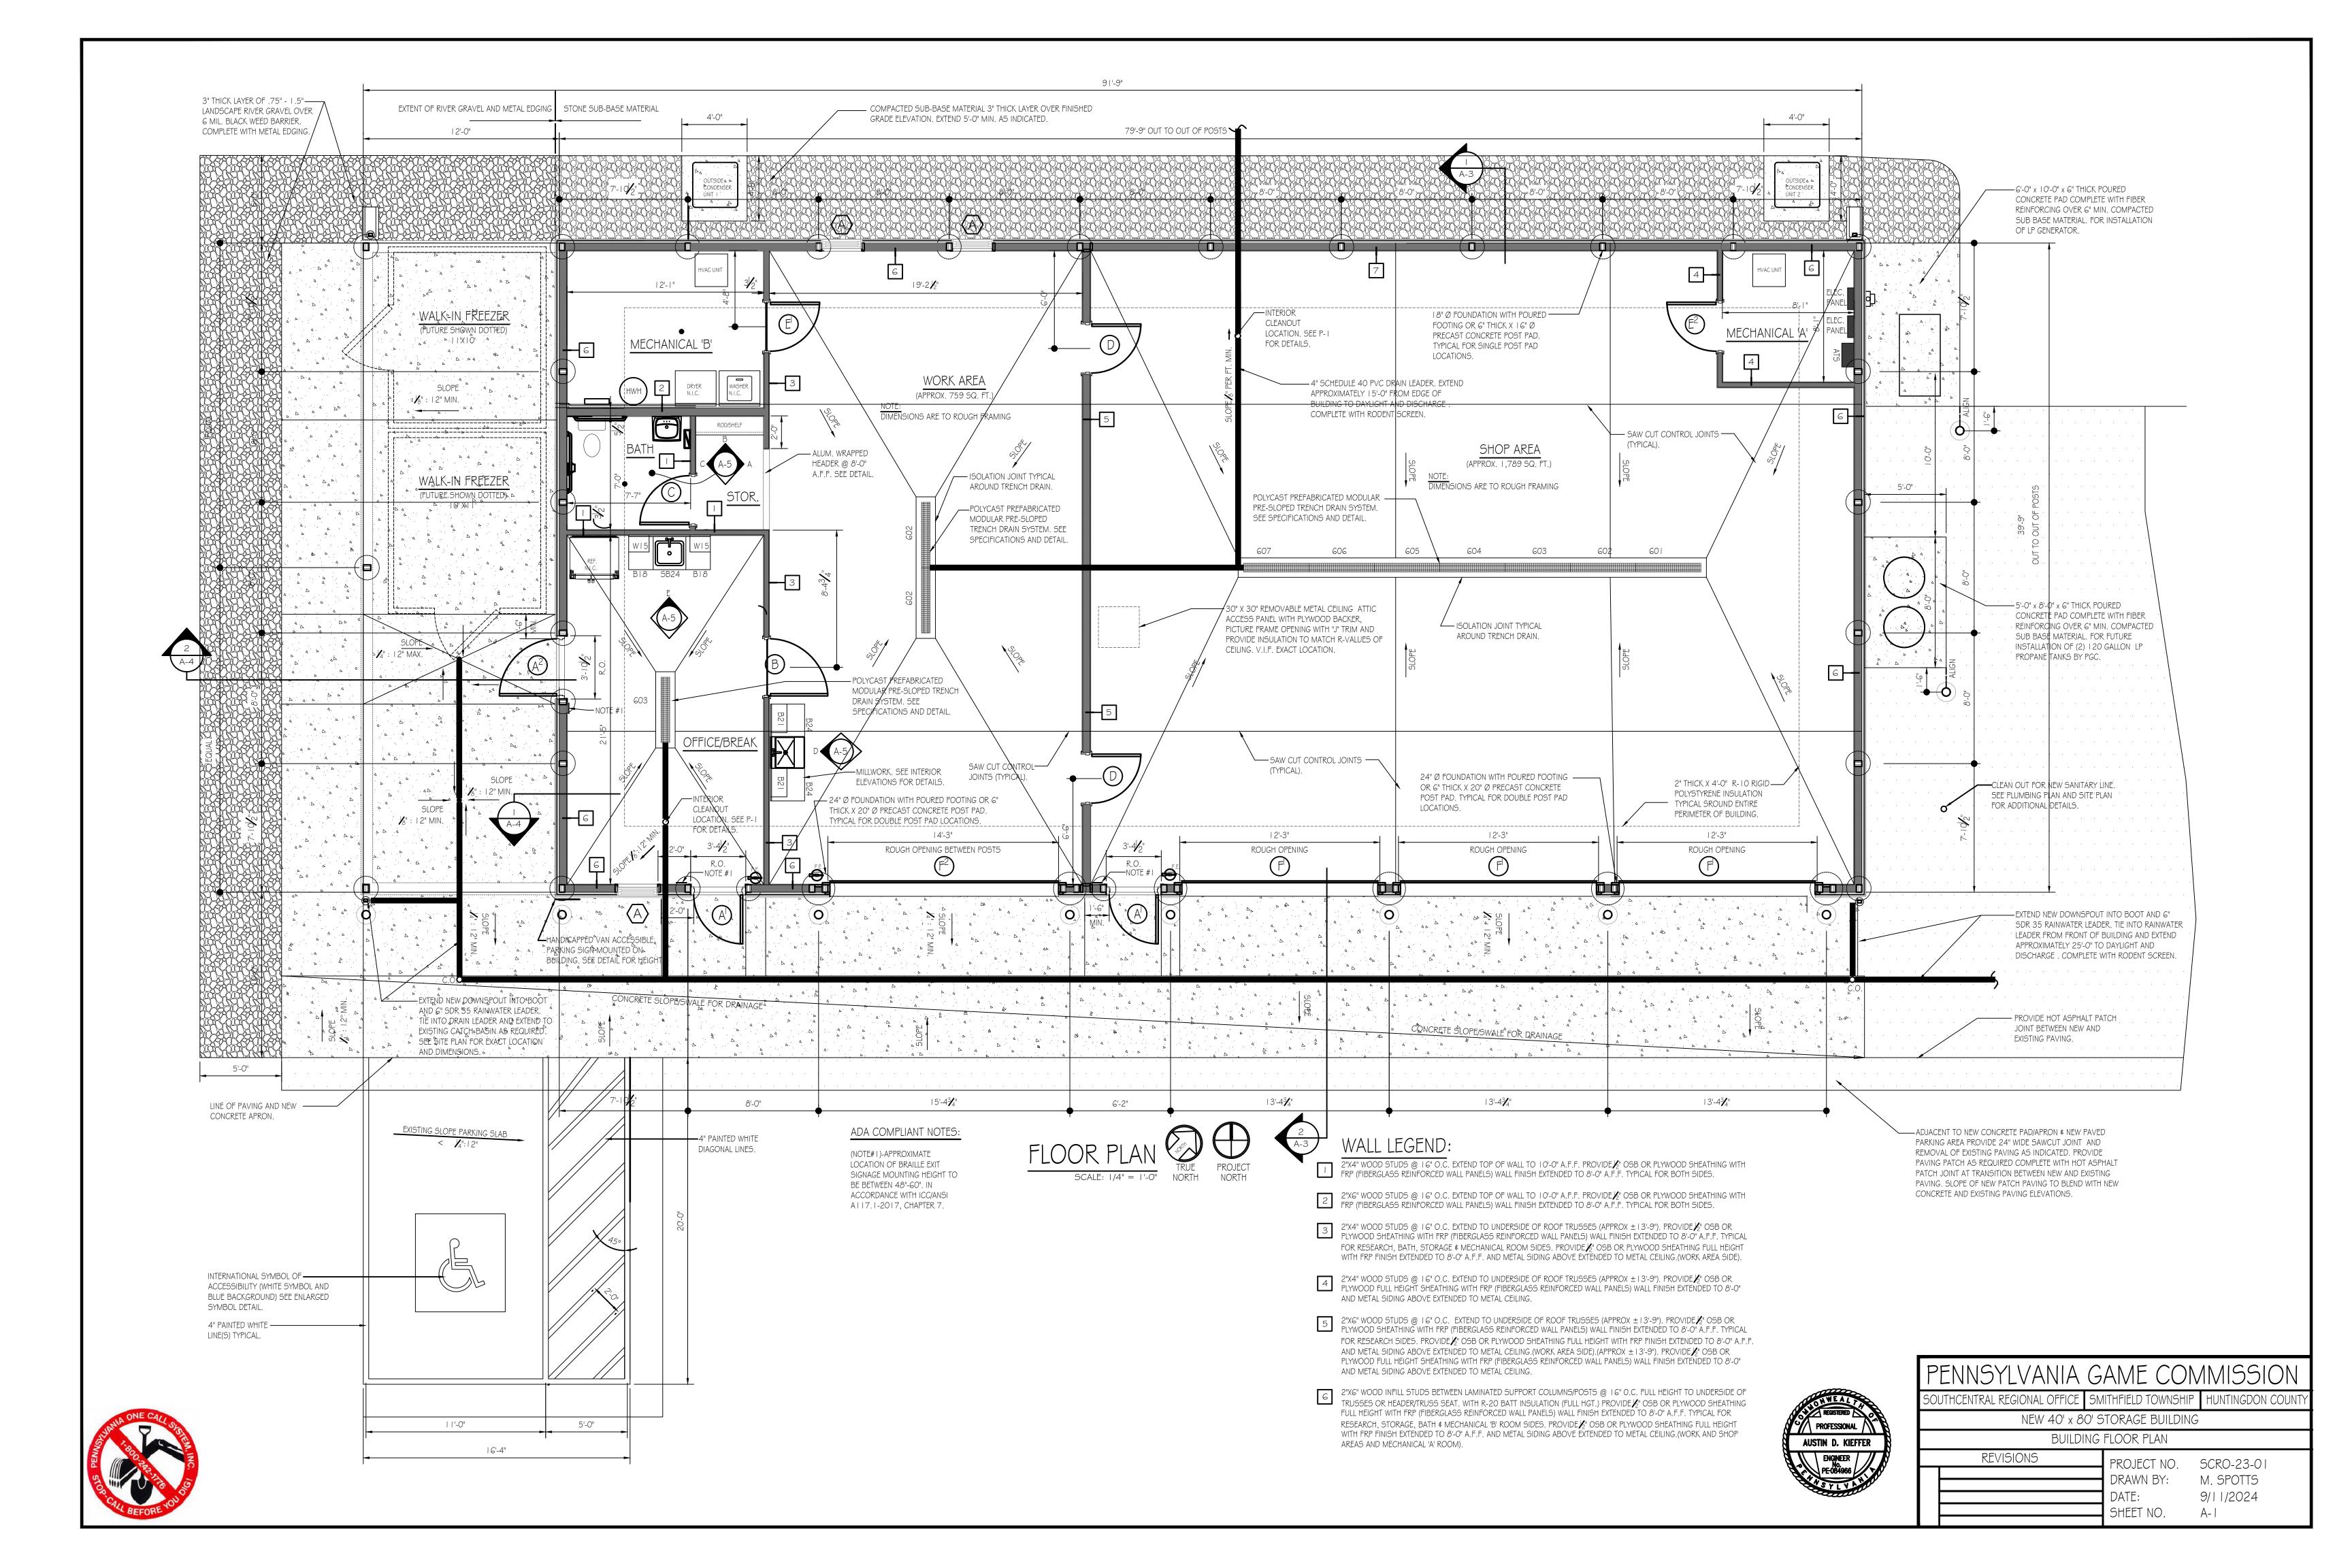
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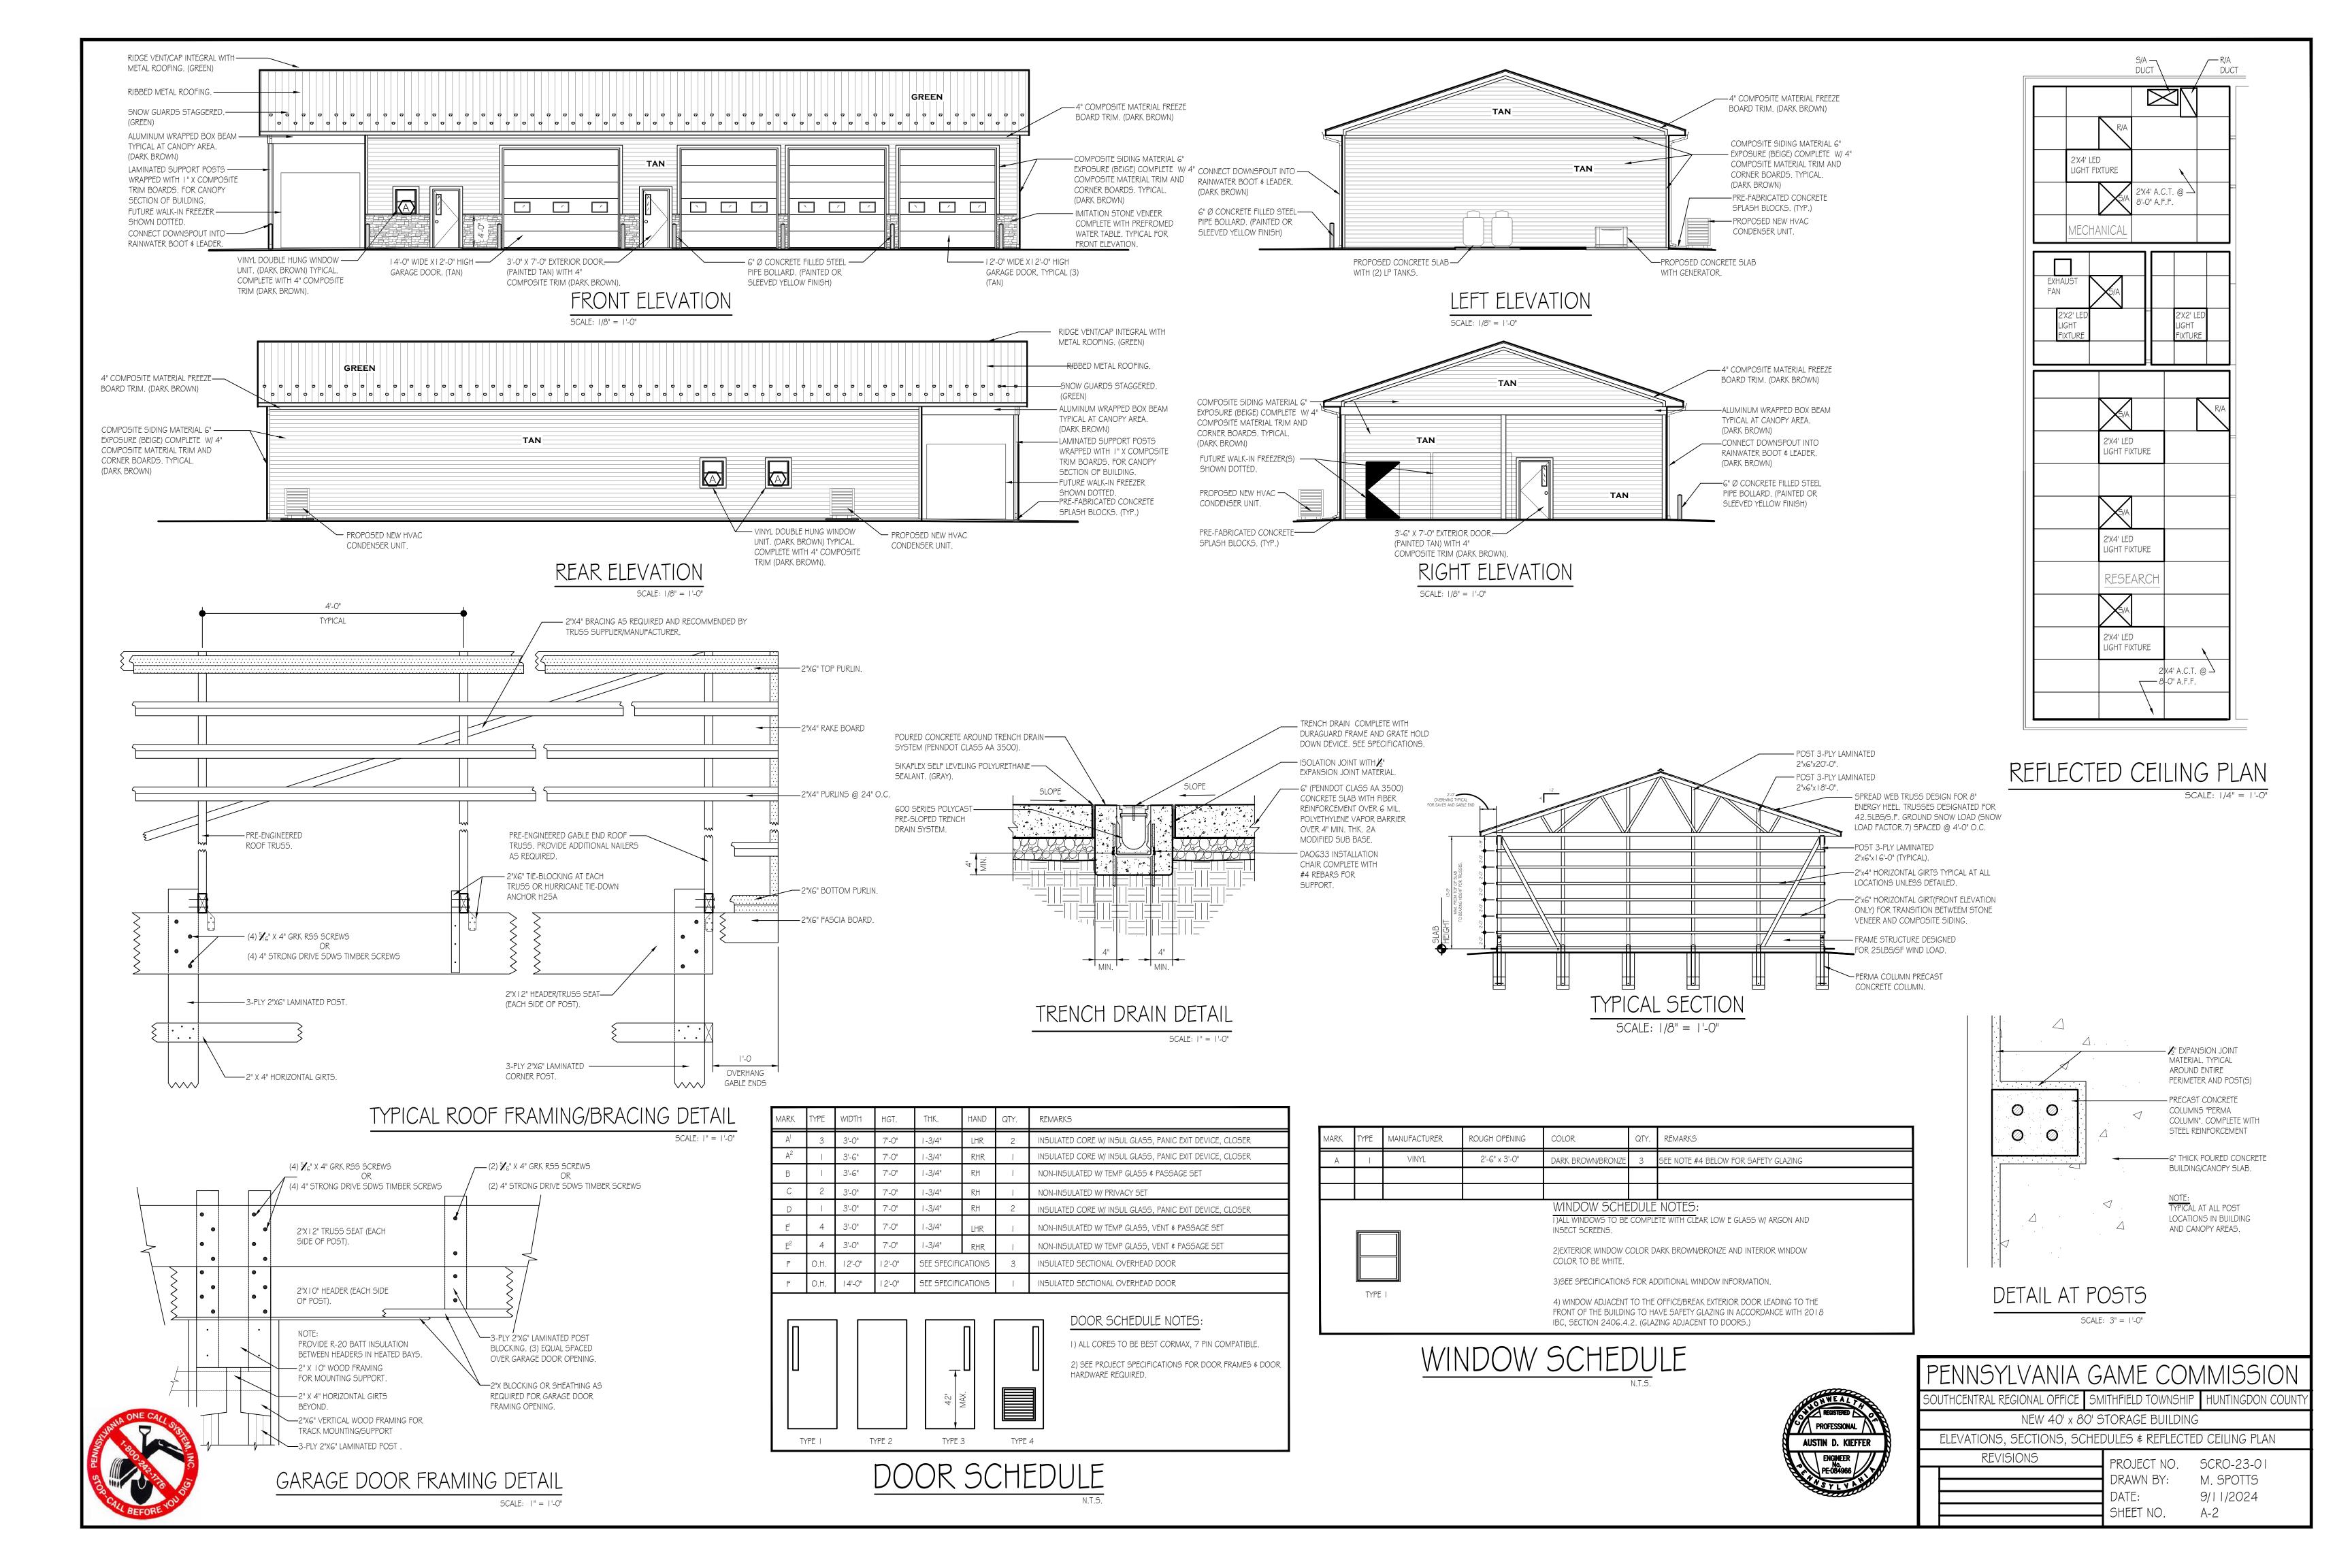
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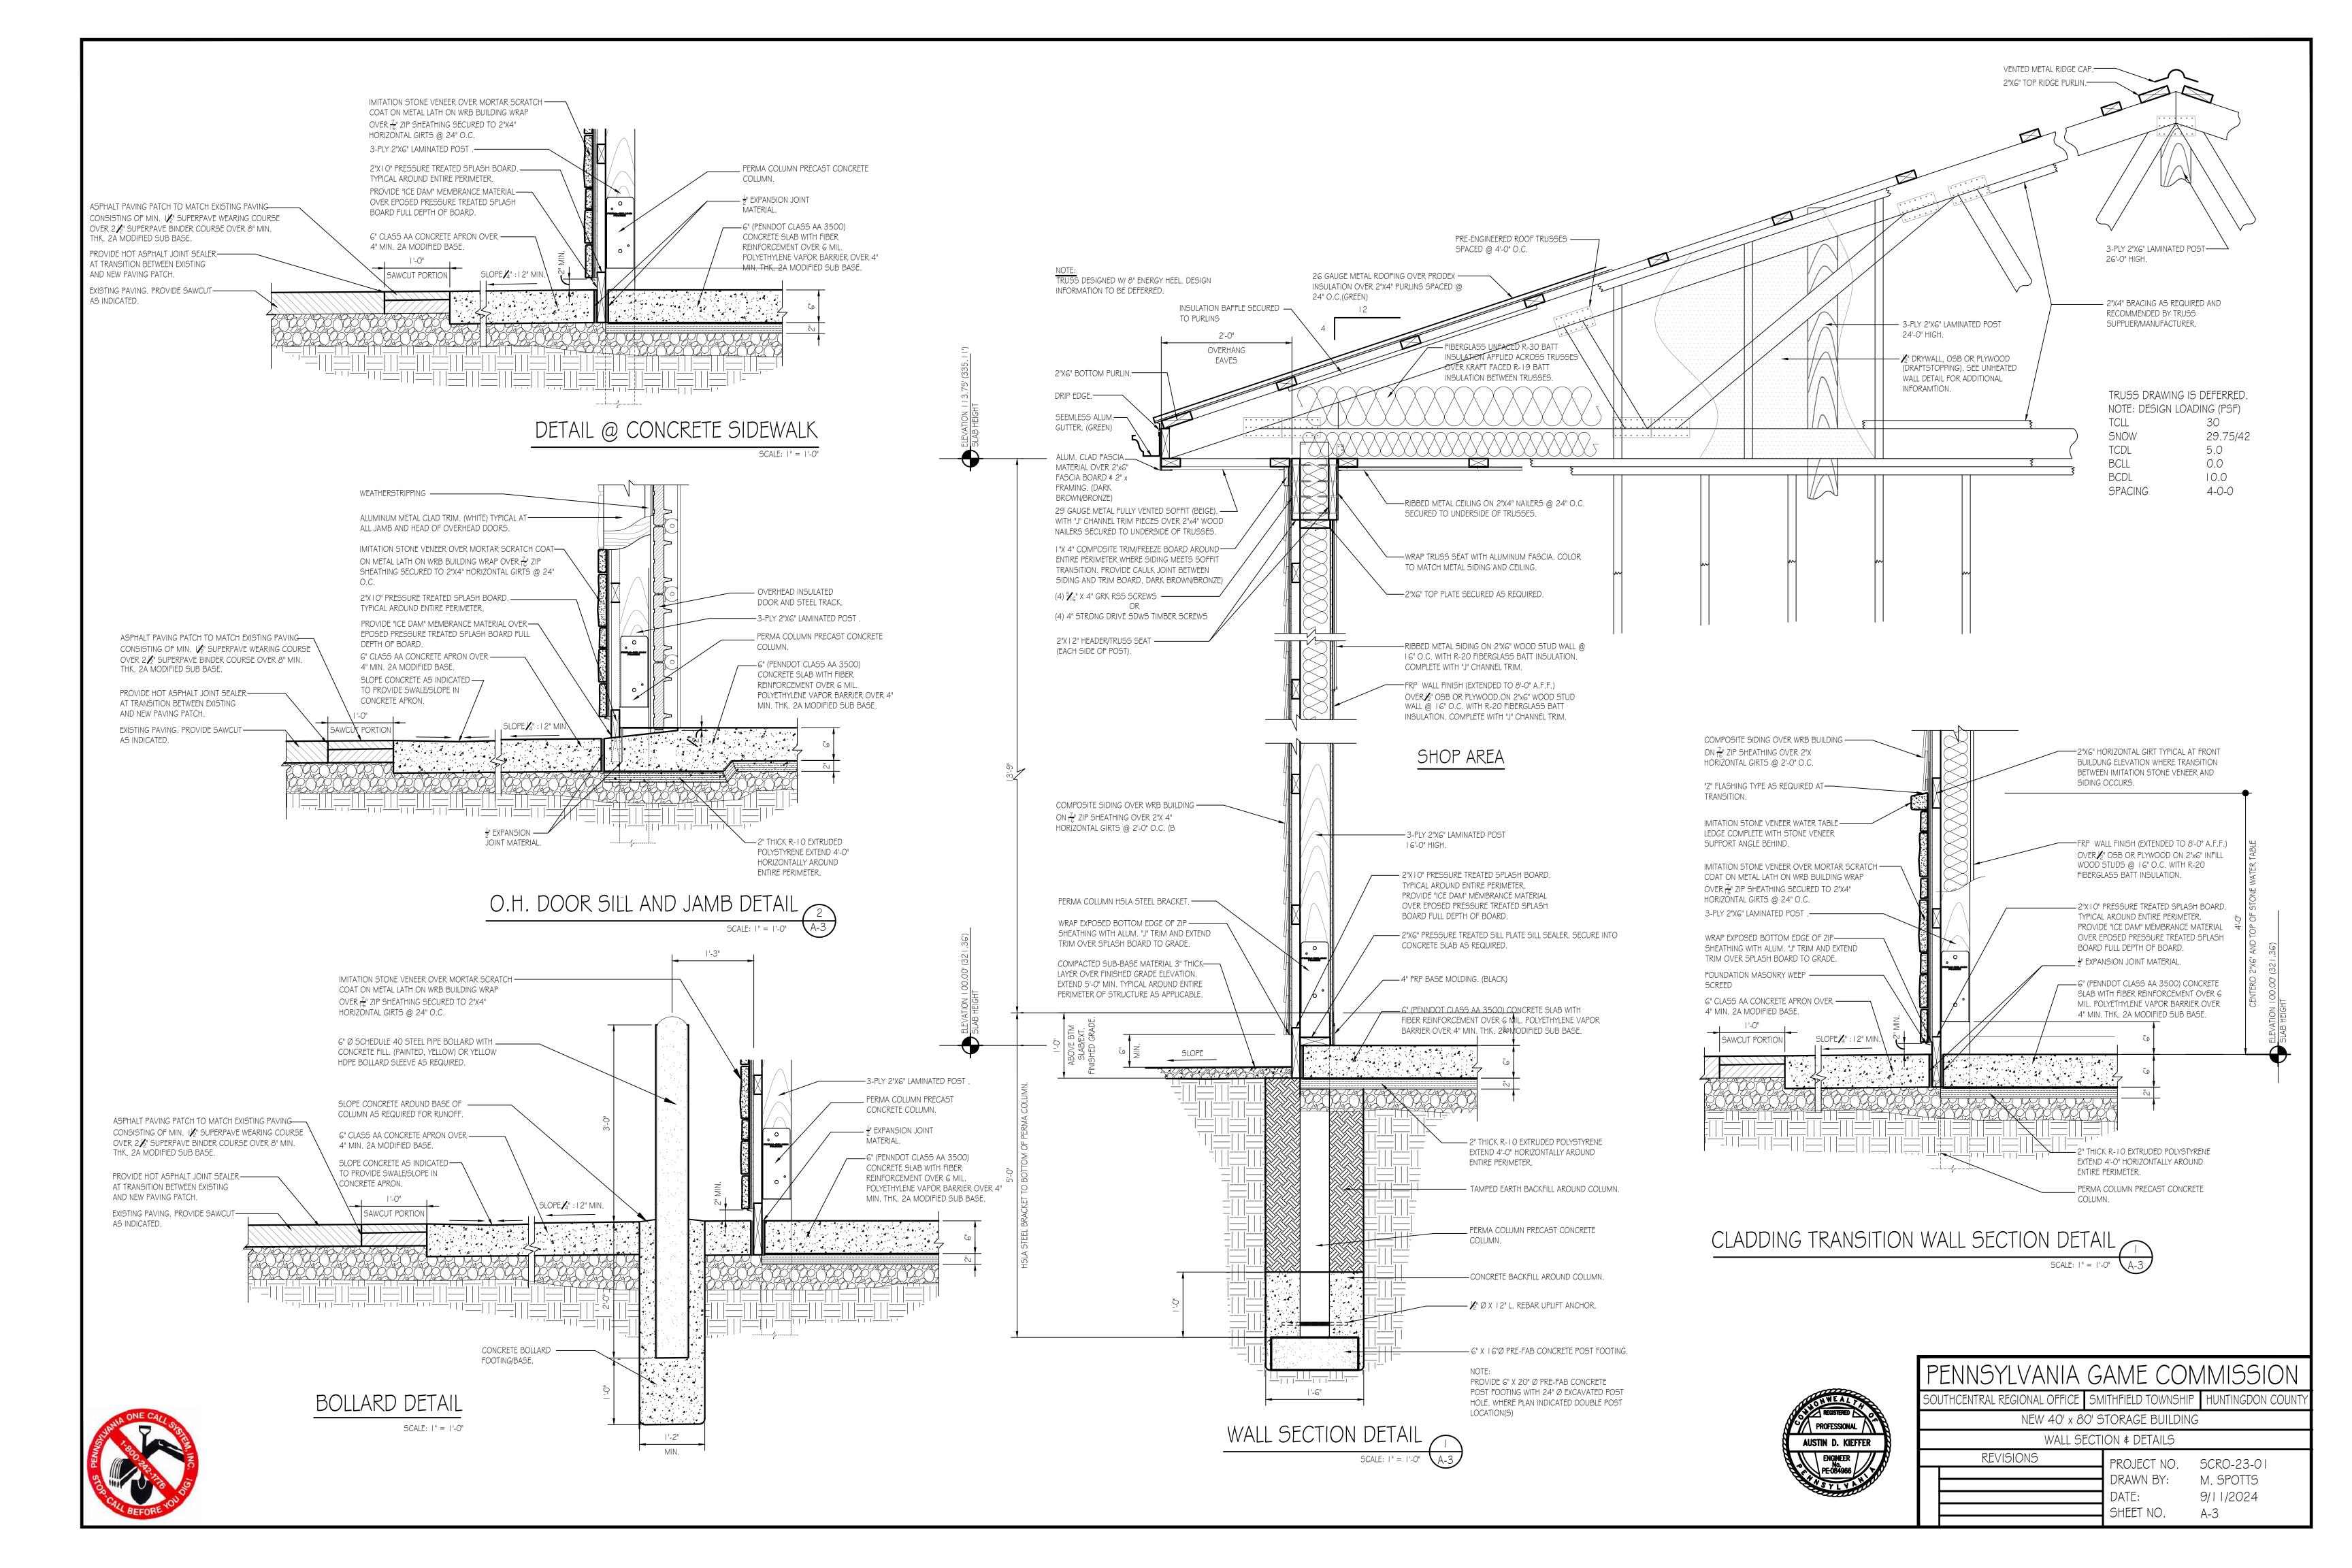










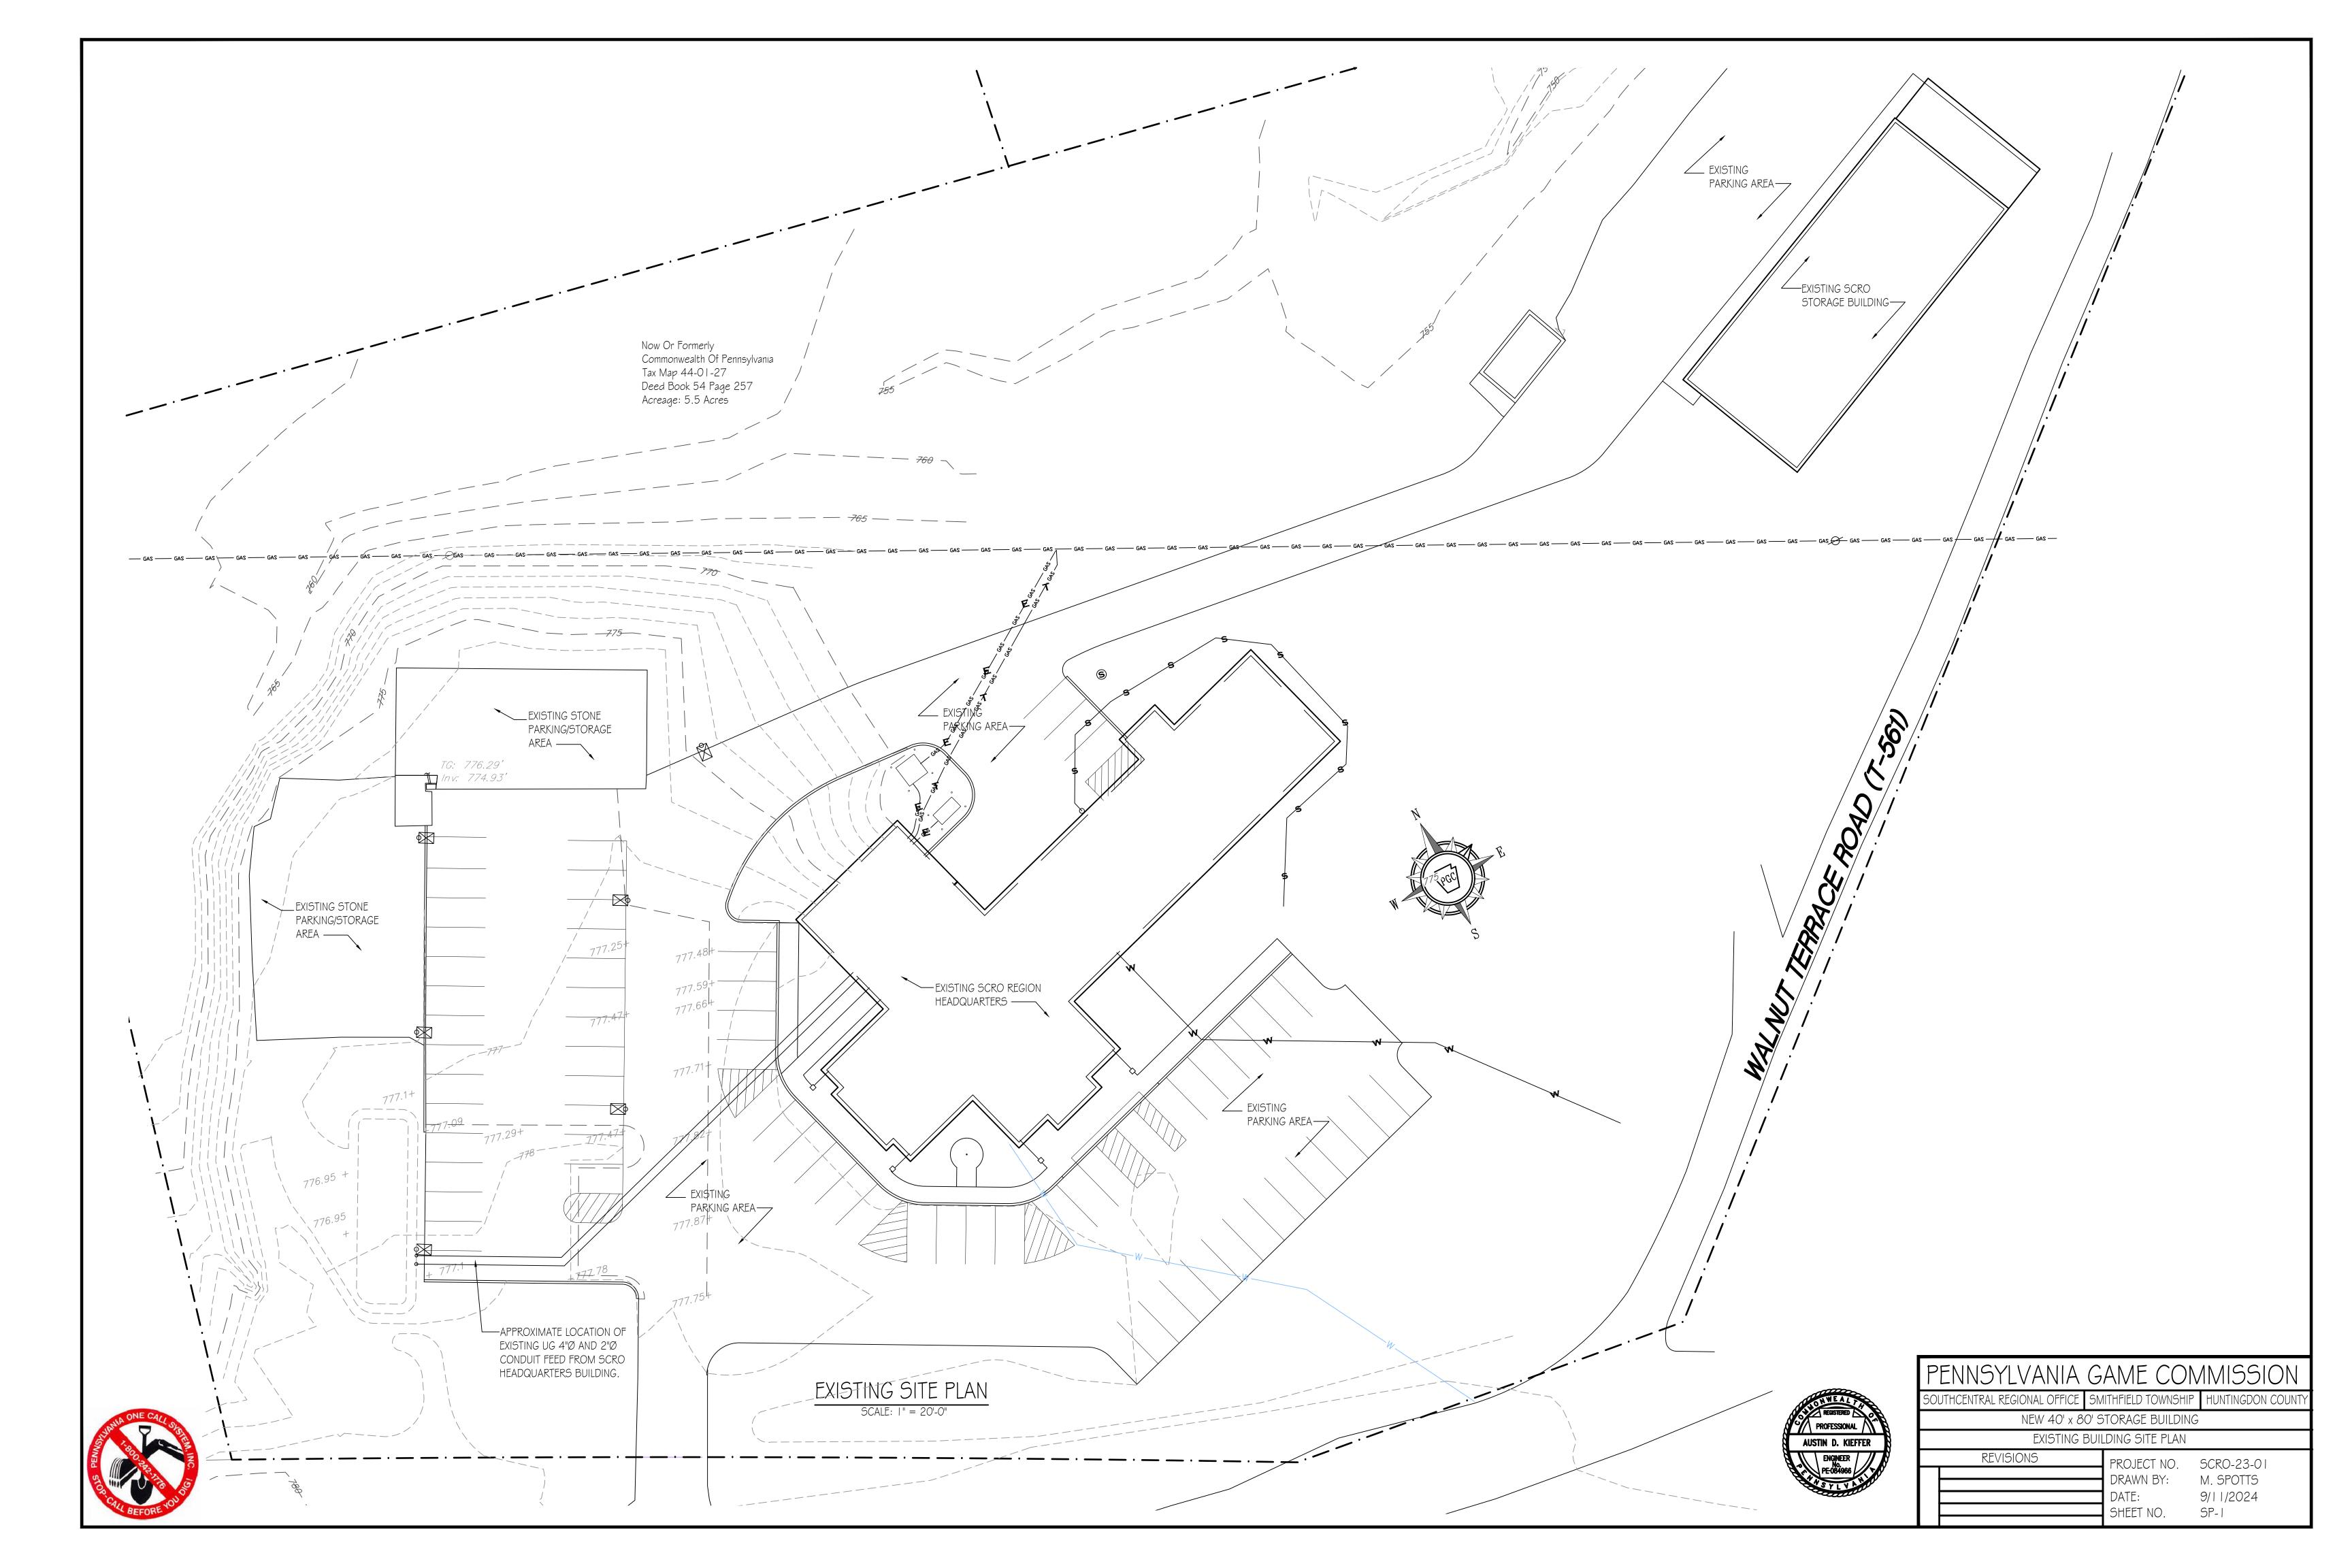


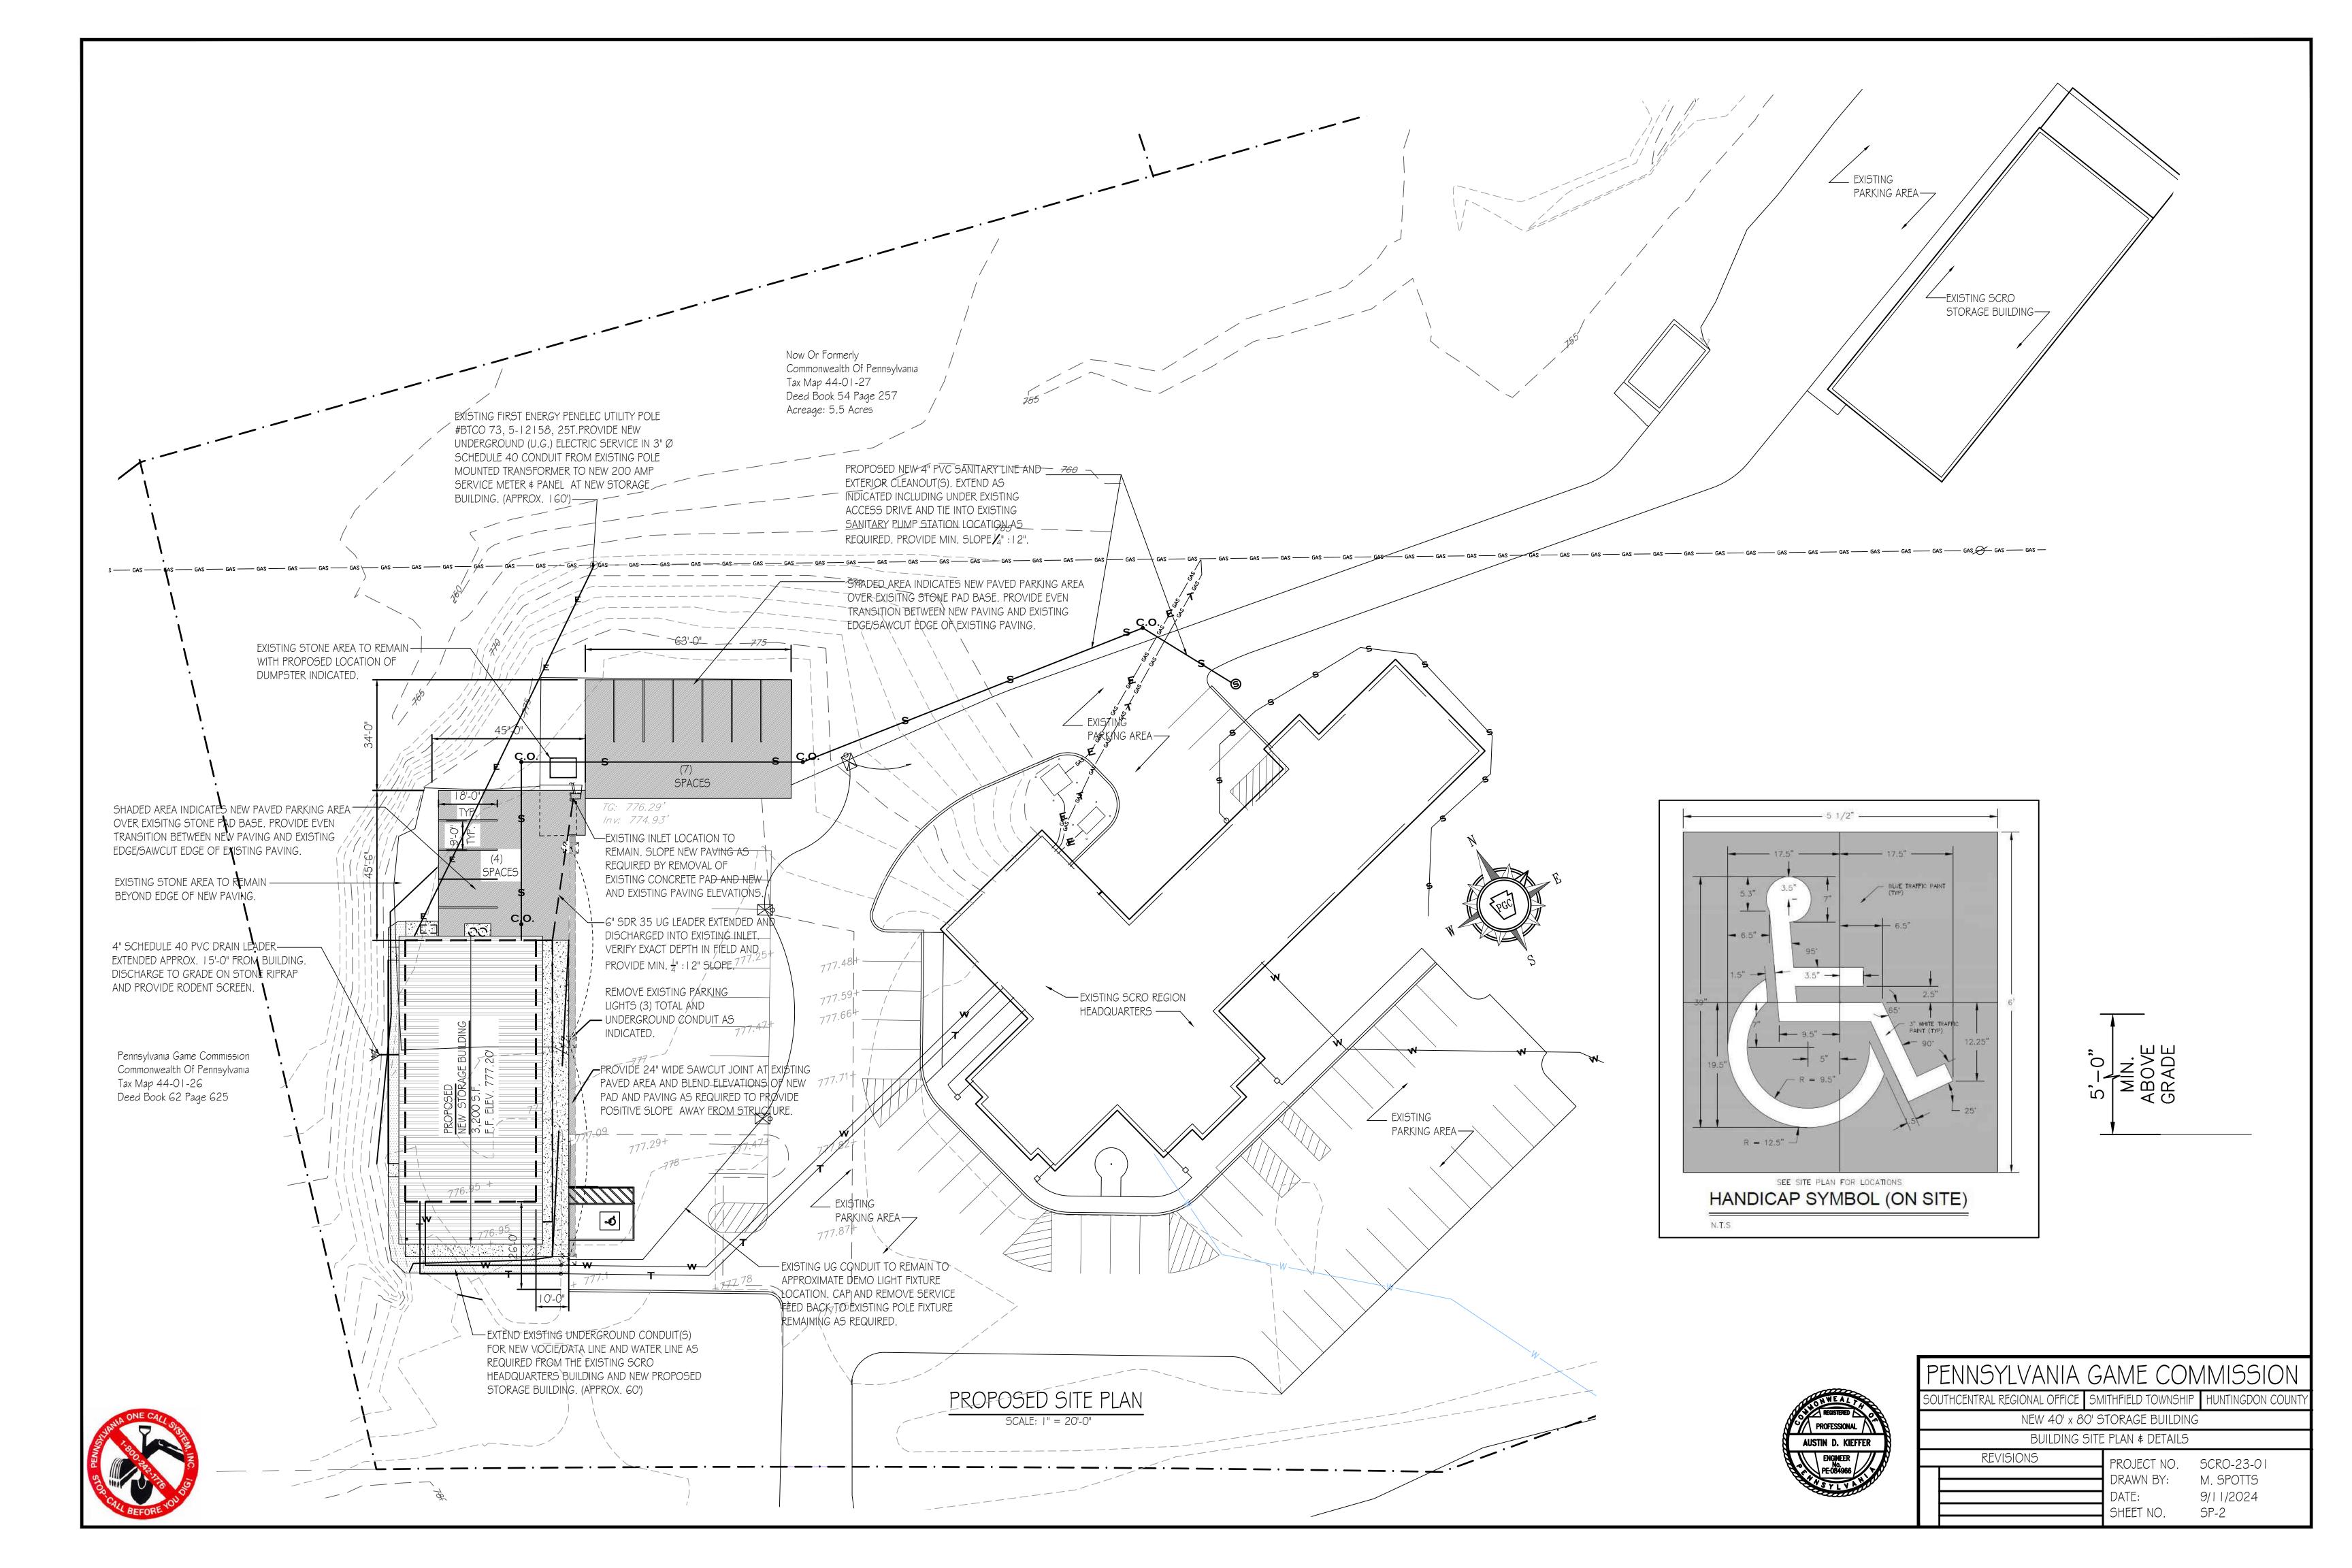


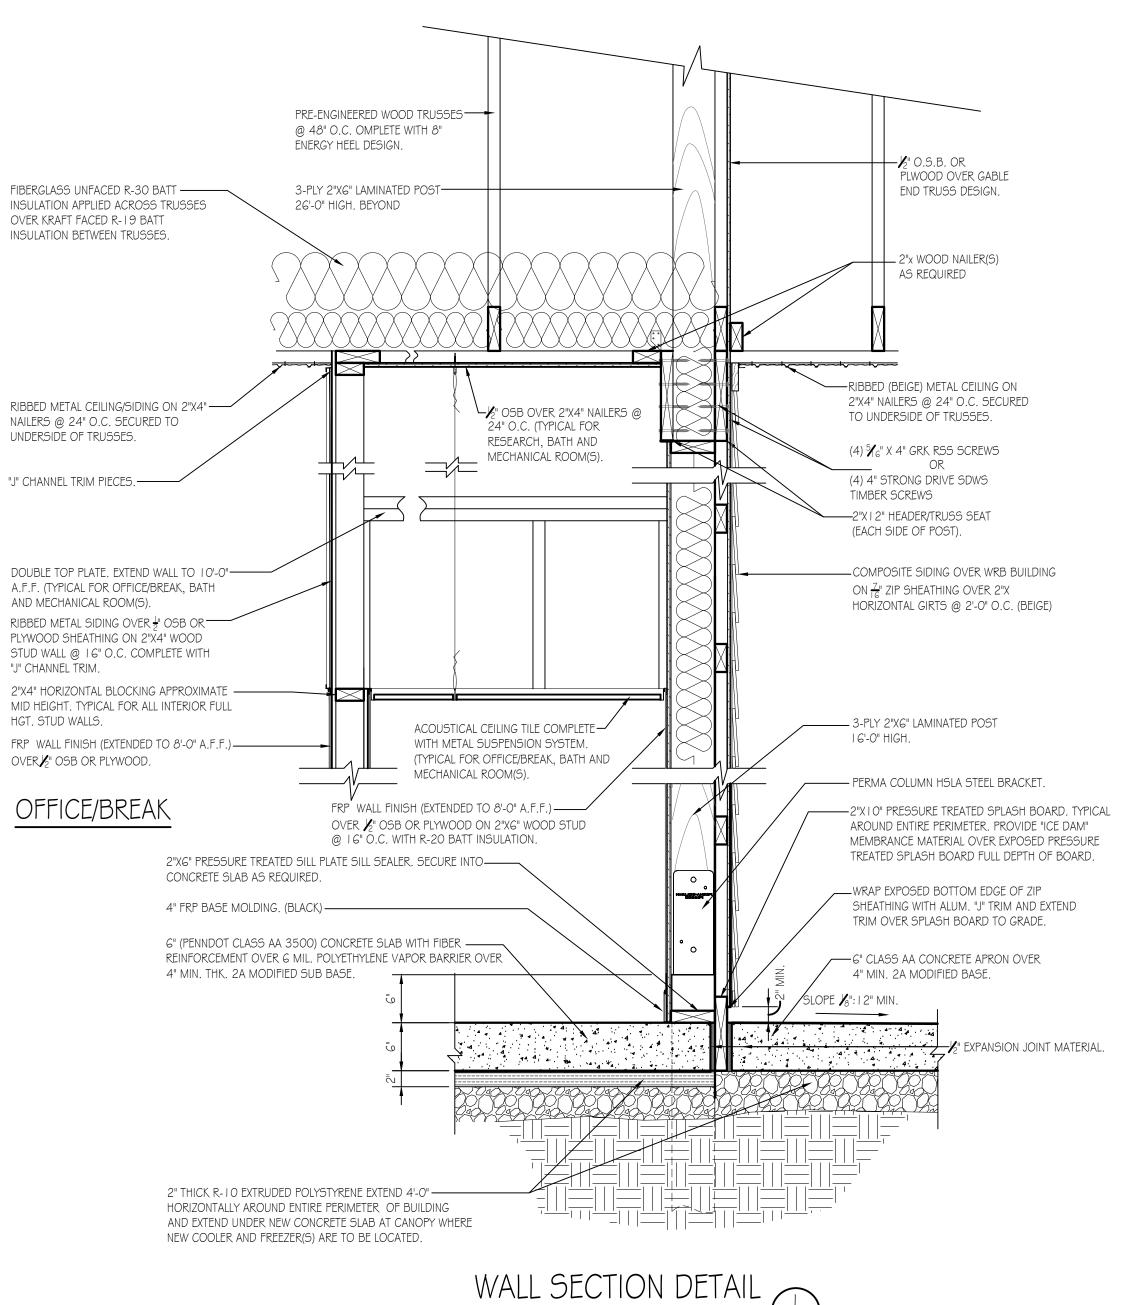



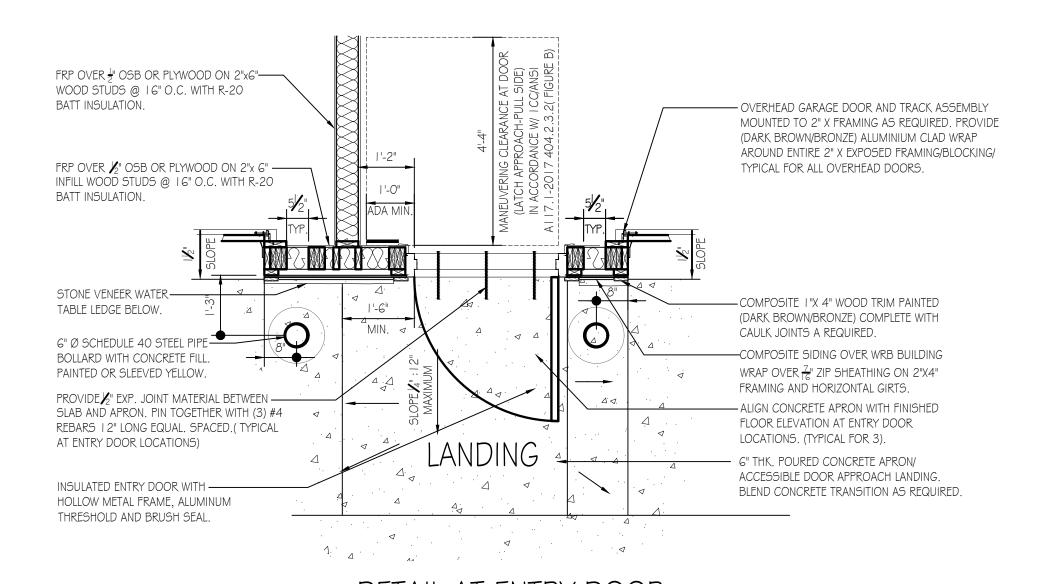

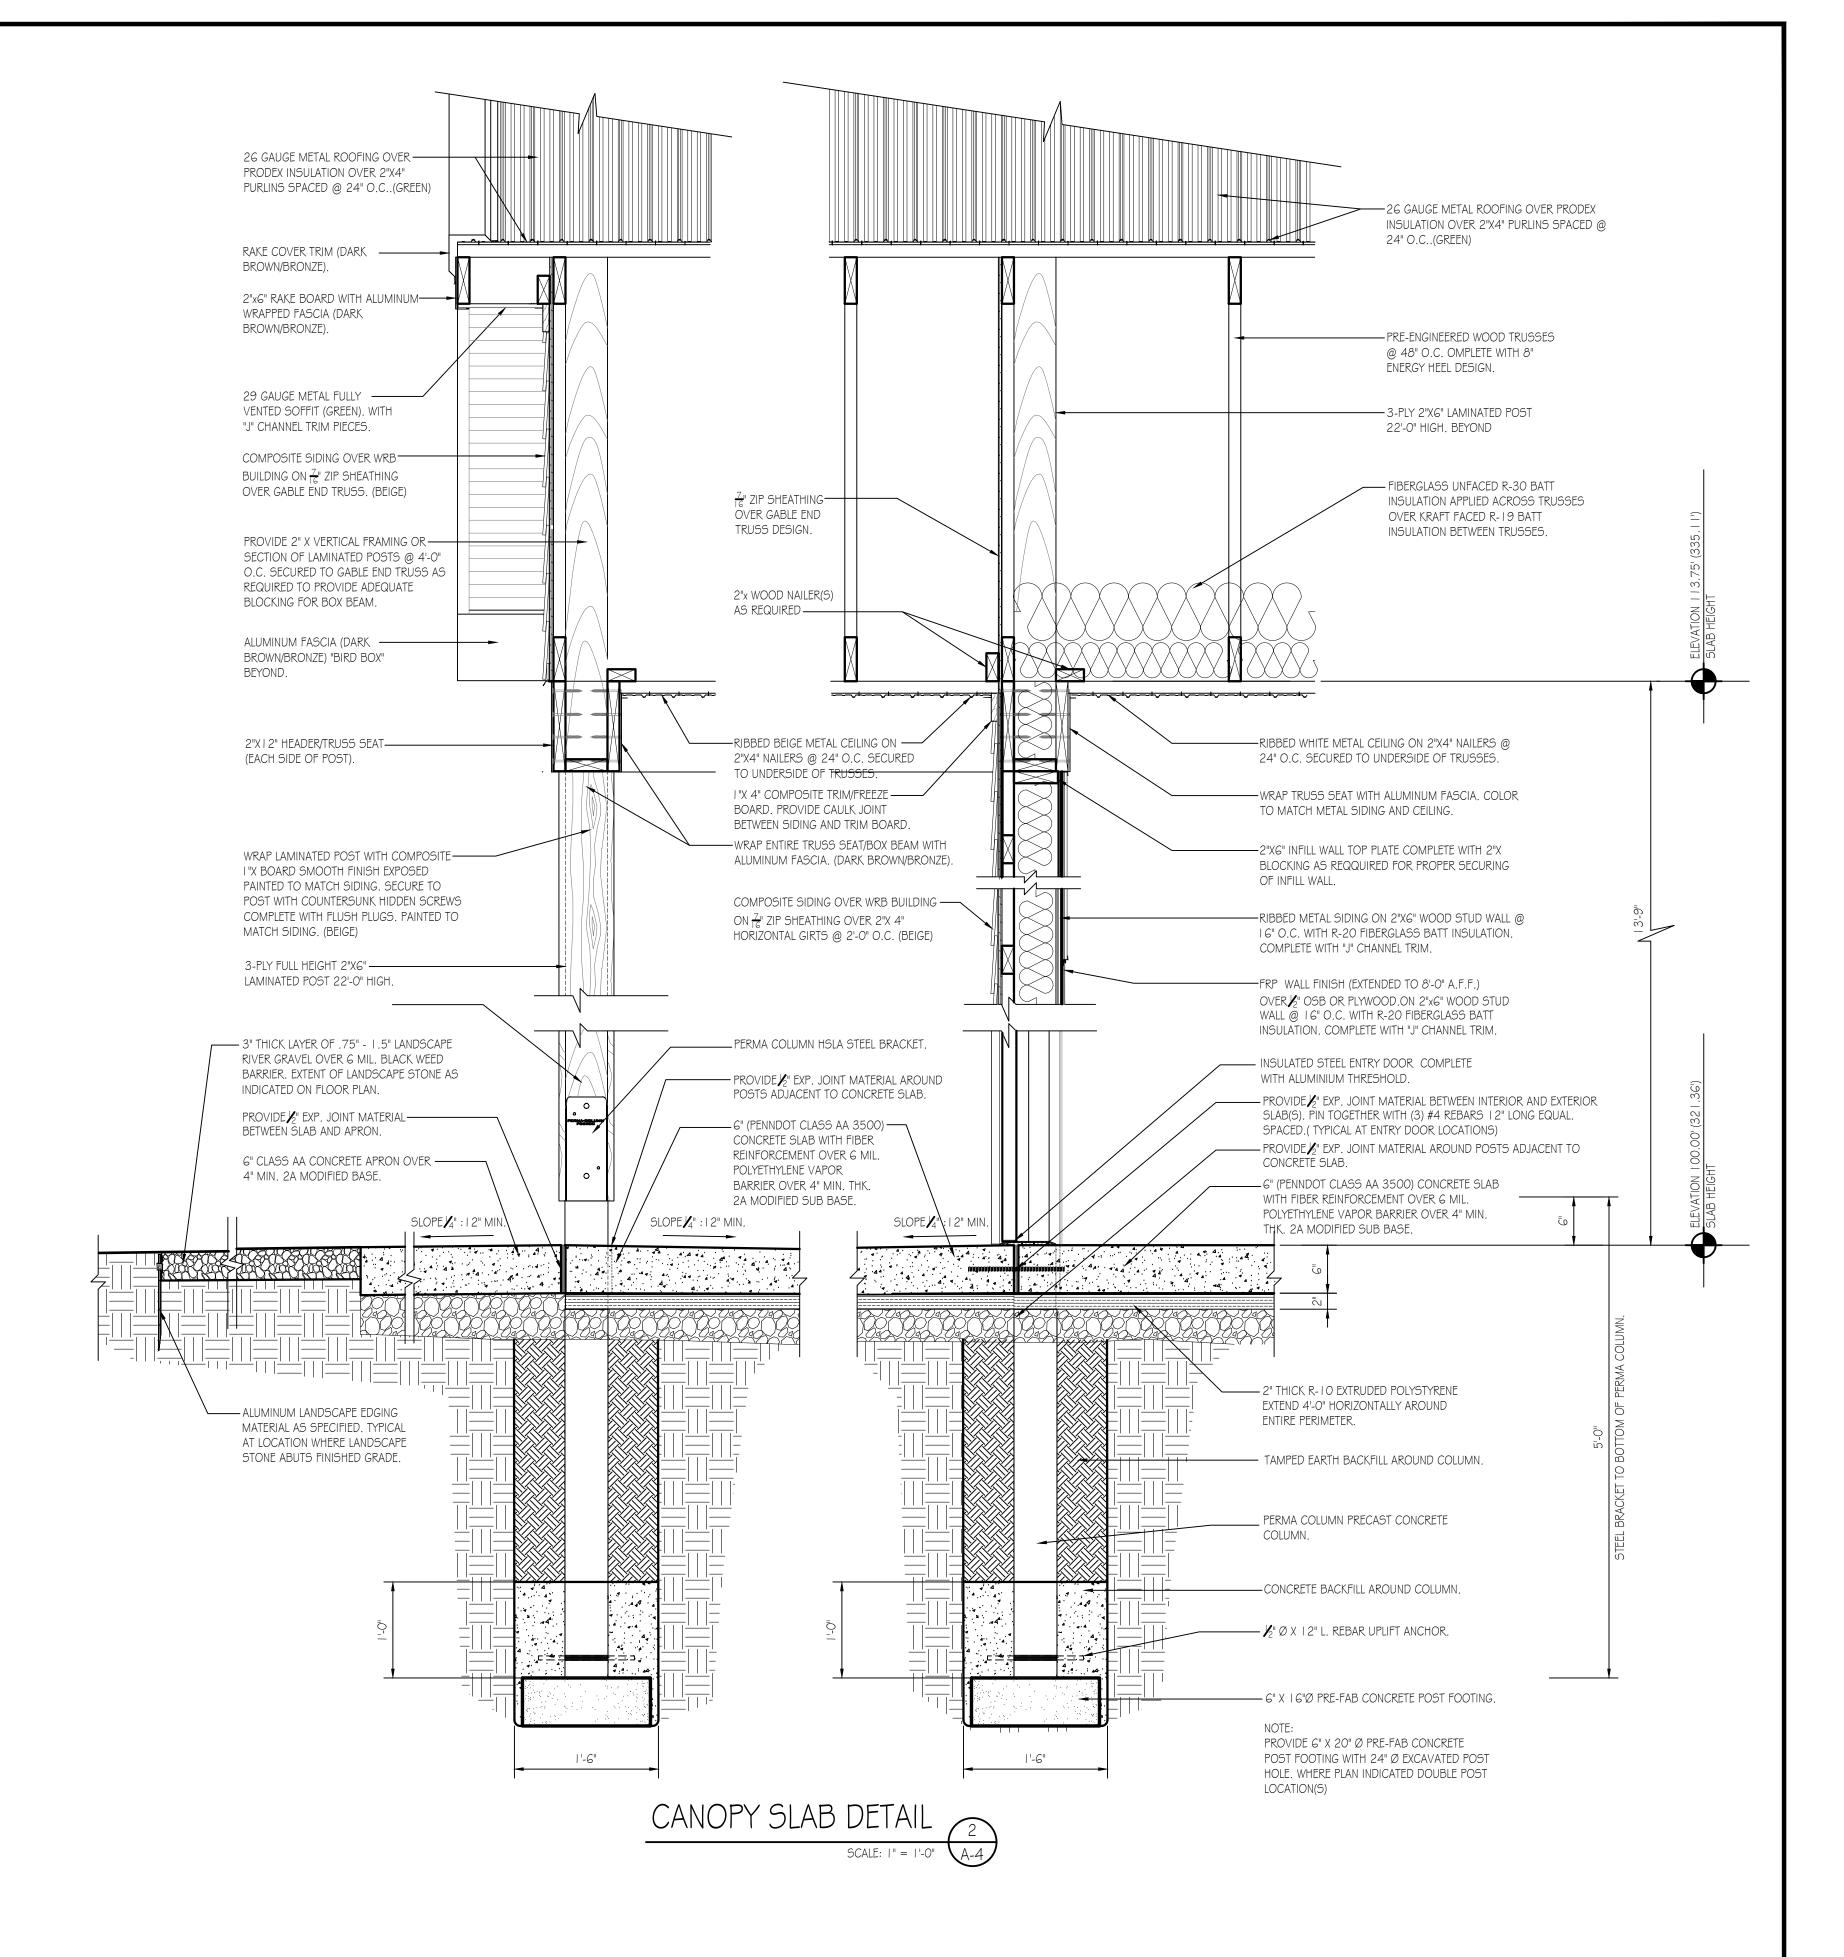

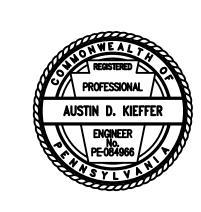


PENNSYLVANIA	GAME CON	MISSION
SOUTHCENTRAL REGIONAL OFFICE	SMITHFIELD TOWNSHIP	HUNTINGDON COUNTY


NEW 40' x 80' STORAGE BUILDING WALL SECTION & DETAILS

REVISIONS

PROJECT NO. SCRO-23-01 DRAWN BY: M. SPOTTS 9/11/2024 SHEET NO. A-4




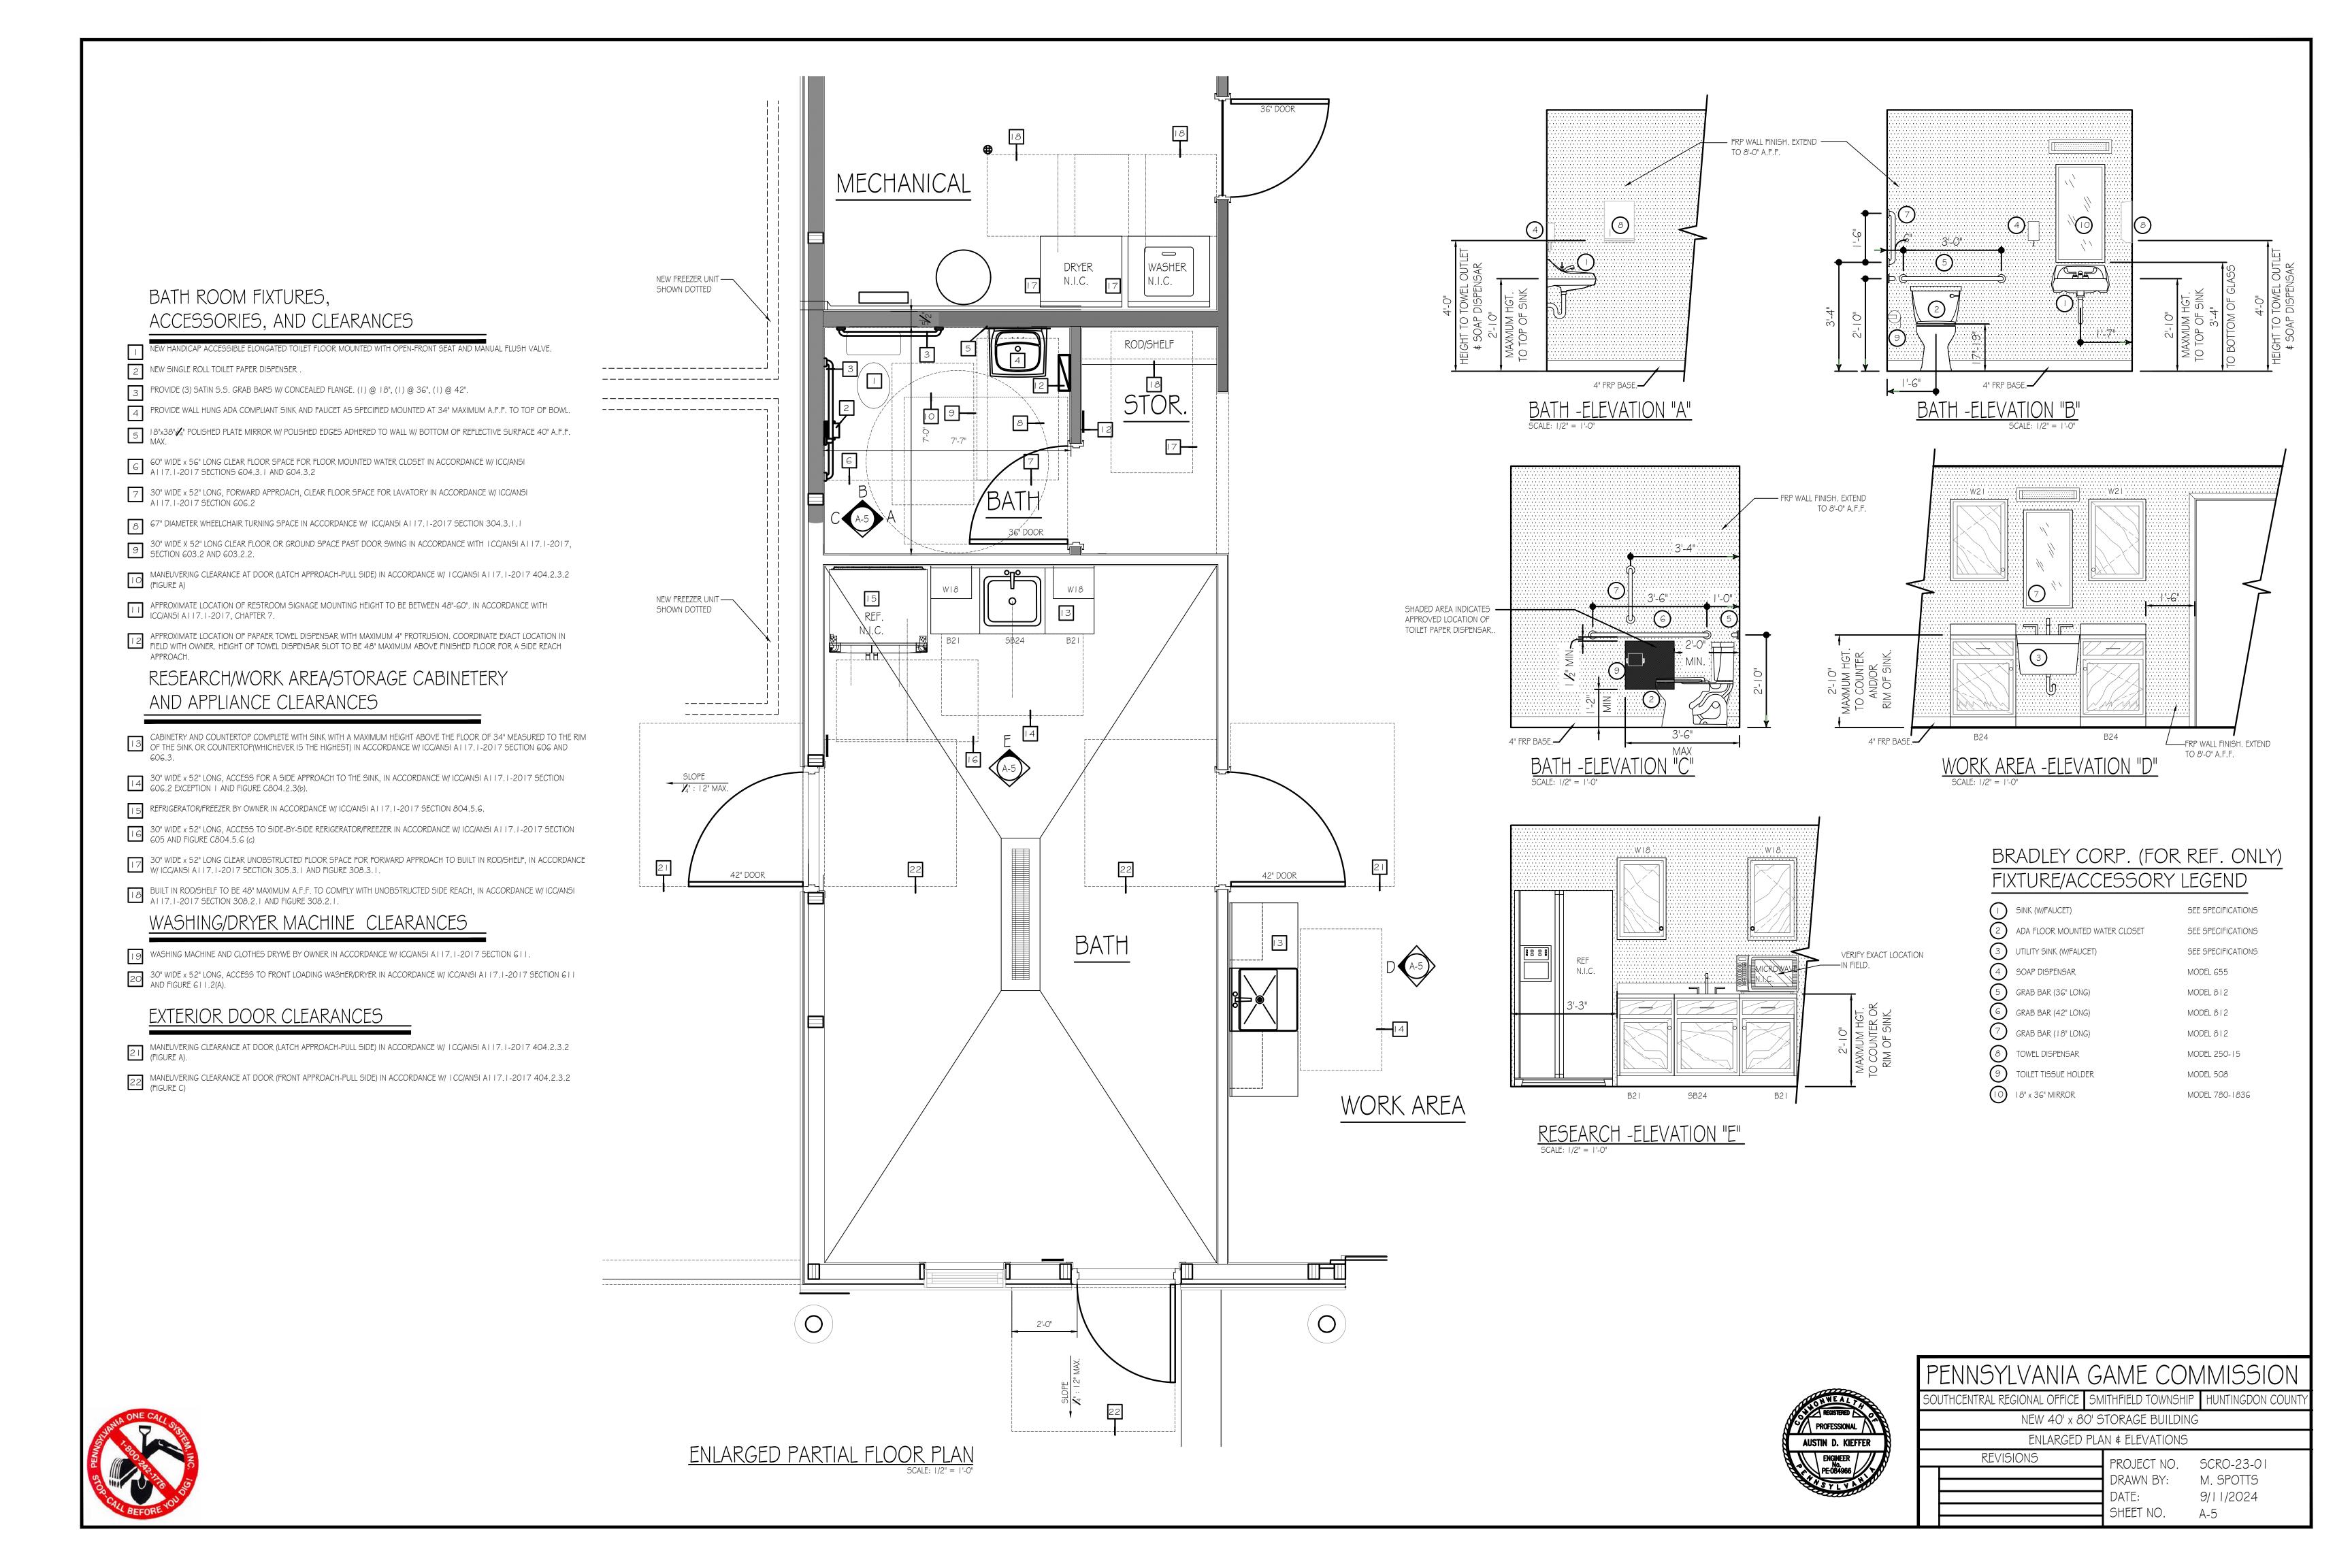

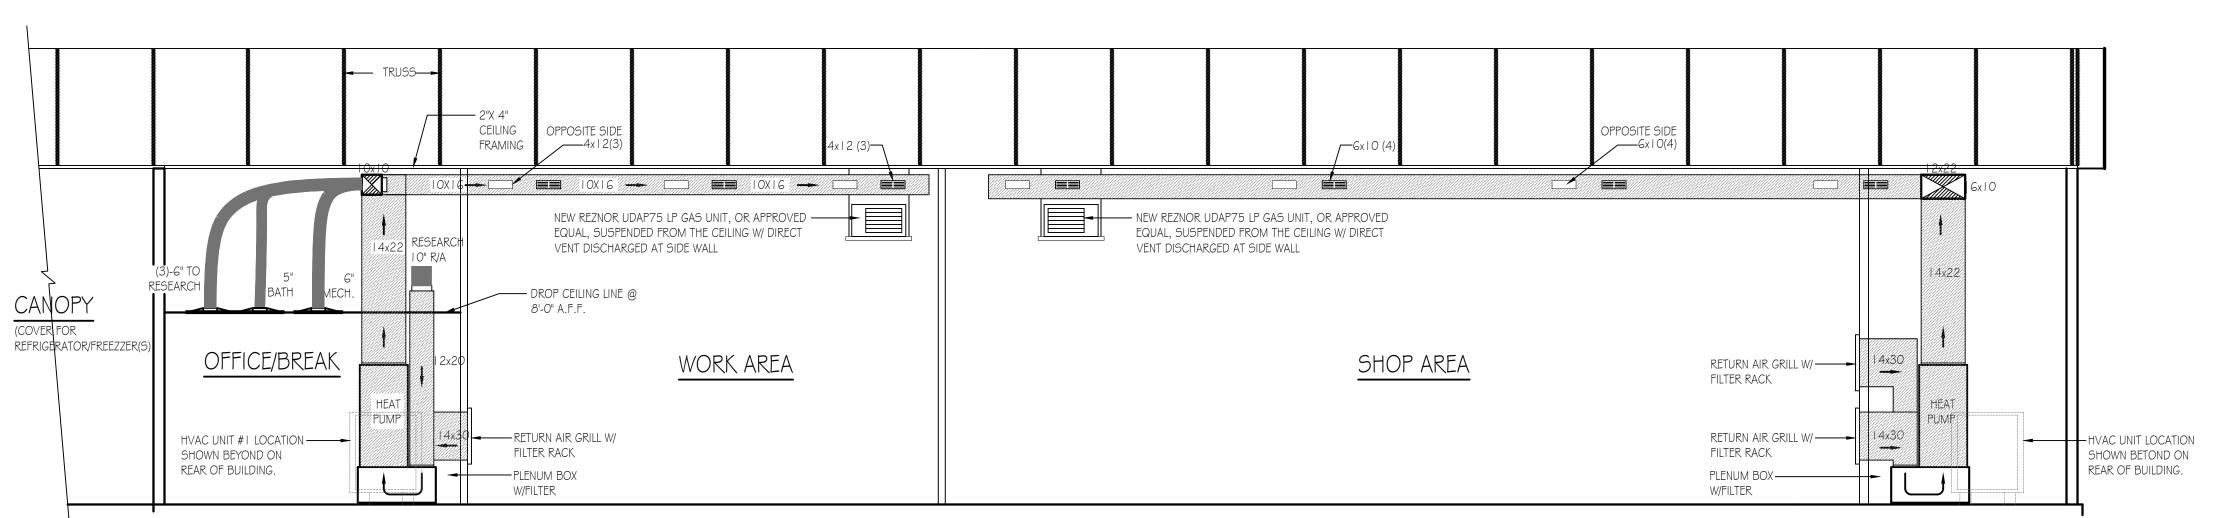

BUILDING SECTION - MECHANICAL (HVAC)

SCALE: 1/4" = 1'-0

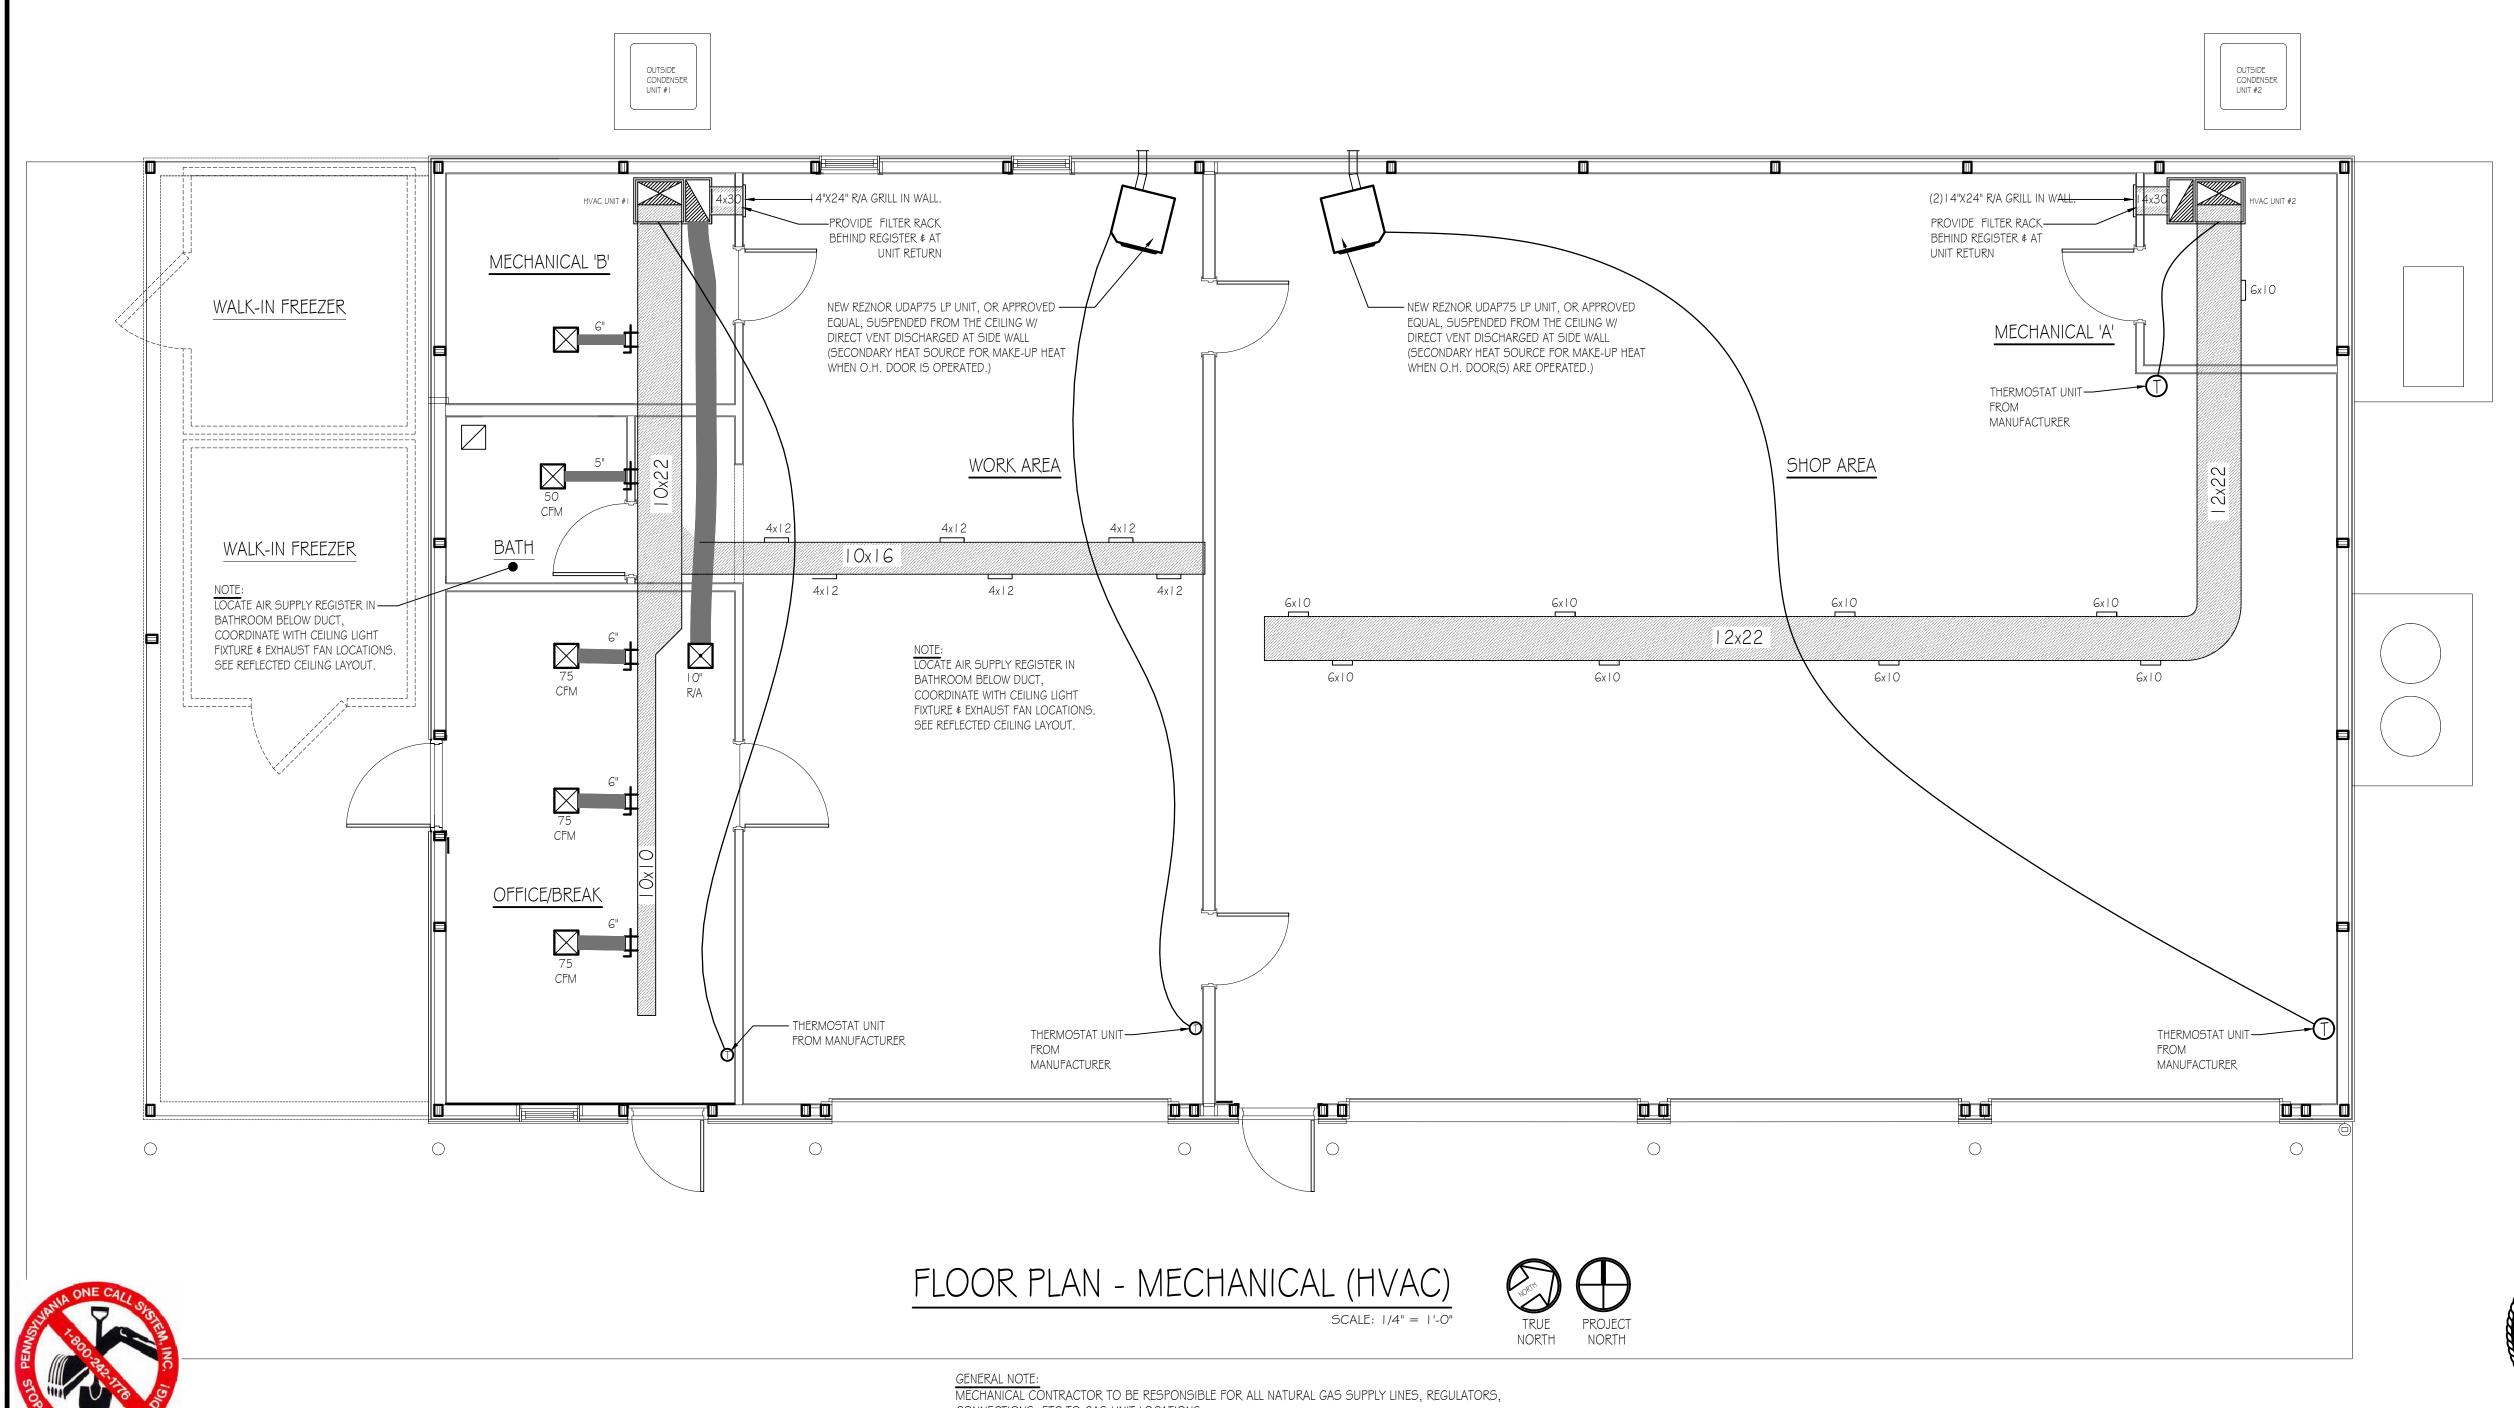

CONNECTIONS, ETC TO GAS UNIT LOCATIONS.

MECHANICAL CONSTRUCTION NOTES: HVAC SYSTEM TO BE A BOSCH HEAT PUMP SYSTEM. LAYOUT OF DUCTS, DUCT SIZES AND DIFFUSERS ARE MEANT TO BE USED AS A GUIDELINE. ACTUAL RUNS, SIZES AND LOCATIONS TO BE DETERMINED BY MANUFACTURER'S MODEL. THE FOLLOWING STEPS SHOULD BE FOLLOWED IN THE DESIGN AND INSTALLATION OF THE HVAC SYSTEM TO ENSURE EFFICIENCY AND COMFORT.

- I. DETERMINE ROOM-BY-ROOM AND AIR-FLOWS USING ACCA MANUAL J CALCULATION PROCEDURES. (OR SUBSTANTIALLY EQUIVALENT)
- 2. SIZE DUCT SYSTEM ACCORDING TO ACCA MANUAL D CALCULATION PROCEDURES. (OR SUBSTANTIALLY EQUIVALENT)
- 3. SIZE HVAC EQUIPMENT TO SENSIBLE LOAD USING ACCA MANUAL S CALCULATION PROCEDURES (OR SUBSTANTIALLY EQUIVALENT).
- 4. INSTALL EQUIPMENT \$ DUCTS ACCORDING TO DESIGN SPECIFICATIONS USING INSTALLATION
- PROCEDURES FROM SMACNA / MANUFACTURERS' SPECS.

 5. INSTALL SO STATIC AIR PRESSURE DROP ACROSS THE AIR HANDLER IS WITHIN MANUFACTURER AND
- DESIGN SPECIFICATIONS.
- 6. PROVIDE BALANCED AIR FLOWS BETWEEN SUPPLY AND RETURN SYSTEMS TO MAINTAIN NEUTRAL PRESSURE
- 7. EQUIPMENT AND ASSOCIATED ITEMS MUST BE APPROVED BY PGC HARRISBURG ENGINEERING DIVISION BEFORE START OF INSTALLATION.

FURNISH AND INSTALL A HEAT PUMP TO BE A 5 TON BOSCH BOVA - 060-HDN I - M I 8M OUTSIDE CONDENSAR UNIT, W/ BVA-48WN I -M20 INDOOR AIR HANDLER/ FURNACE AND EHK- I 5B- I 5kW MINIMUM BACKUP STAGED ELECTRIC HEAT STRIP. UNITS TO ACHIEVE A MINIMUM I 7 SEER AND 8.0 HSPF (OR SUBSTANTIALLY EQUIVALENT).

LP GAS PIPING NOTES: THE MECHANICAL CONTRACTOR SHALL FURNISH AND INSTALL NEW RIGID LP GAS PIPING SYSTEM INTO THE BUILDING ENVELOPE THEN CONTINUE WITH CSST FLEXIBLE GAS PIPING, VALVES, PIPE HANGERS, AND ALL MECHANICAL MATERIALS REQUIRED TO CONNECT TO PROPANE TANKS TO NEW SUSPENDED

- I. RIGID PIPING -BLACK STTEEL PIPE TO COMPLY WITH ASTM A53/A53M, SCEDULE 40, TYPE E OR S GRADE B CARBON STEEL COMPLETE WITH ALL FITTINGS TO COMPLY WITH ASME B I 6.3.
- 2. FLEXIBLE PIPING -CSST "Z" DIAMETER -300 SERIES STAINLESS STEEL STRIP CONFORMING TO ASTM A240 RATED FOR 25 PSI AND HAVE AN ELEVATED PRESSURE RATING OF 1 25G FOR SIZES UP TO 1 "Z"



Pr	oduct Specifications
•	5 inch Touch Screen 854 x 480 Pixels

► Supports 2 Transformer Systems (R/RC and RH)

C-Wire Required for Installation

UNIT HEATER. PIPING SPECS ARE AS FOLLOWS:

AND 25G FOR 1 🔏 " AND 2".

- C-Wire Required for Installation
 7 Relay Terminals: G, Y, Y2, W/E, W2/AUX, 0/B, H/DH
- 1 Data Terminal: receives fault messages from Bosch Water Source Heat Pumps
- Bosch Water Source Heat Pum

 Wi-Fi 802.11 b/g/n @ 2.4GHz

 5 year limited warrantylu
- Thermostat Spare Parts

 Wall Plate, Screwdriver, Screws
 & Wall Anchors, Jumper Cable

 8-733-6

MINIMUM OUTDOOR AIRFLOW RATE CHART

OCCUPANCY CLASSIFICATION	OCCUPANCY DENSITY /SQUARE FOOT	CFM/PERSON	EXHAUST AIRFLOW RATE
BUISNESS-OFFICE	367 SQ.FT./2 PERSONS	5 CFM/ 2 PERSONS-10 CFM	1
BUISNESS -BATH	60 SQ. FT./ I PERSON	-	I I O CFM EXHAUST FAN
BUISNESS -UTILITY	125 SQ. FT./I PERSON	20 CFM/PERSON -20 CFM	-
STORAGE-WORK AREA	855 SQ. FT./3 PERSONS	10 CFM/ 3 PERSONS -30 CFM	-
STORAGE-SHOP AREA	1793 SQ. FT./G PERSONS	10 CFM/ 6 PERSONS -90 CFM	-



PENNSYLVANIA	GAME COI	MMISSION			
SOUTHCENTRAL REGIONAL OFFICE	SMITHFIELD TOWNSHIF	' HUNTINGDON COUNTY			
NEW 40' x 80' STORAGE BUILDING					
MECHANICAL F	LS				
REVISIONS	PROJECT NO.	SCRO-23-01			
l 	DRAWN BY:	M. SPOTTS			

SHEET NO.

9/11/2024

