		40/ 20\ DER SIZI	E: 2-#4/0 \$ 1-#2 AL	
Circuit No.	Circuit (Poles	Breakers Amps	200 AMP Main Service Breaker	Wiring No./Size
1,3	2	40	HVAC Outside Unit	Verify w/M.C
2,4	2	30	HVAC Inside Air Hander Unit	Verify w/M.C
5,7	2	40	HVAC Outside Unit	Verify w/M.C
6,8	2	30	HVAC Inside Air Hander Unit	Verify w/M.C
9,11	2	20	Well Pump	3 - #10
10,12	2	30	Water Heater	3 - #10
13,15	2	20	Septic Dose Pump	3 - #10
16		20	Septic Tank Alarm	3 - #12
17	1	20	Exit Lighting	3 - #12
18		20	Conference Room Lighting	3 - #12
19		20	Offices, Breakroom, Duck Lighting	3 - #12
20		20	Corridor & Mechanical Room Lighting	3 - #12
21		20	Restrooms Lighting	3 - #12
22		20	Duck/Goose Check Lighting	3 - #12
23		20	Exterior Entries Lighting	3 - #12
24		20	Exterior Rear Lighting	3 - #12
25		20	Office Receptacles	3 - #12
26		20	Breakroom Receptacles	3 - #12
27		20	Refrigerator	3 - #12
28		20	Break Room Exhaust Fan	3 - #12
29		20	Duck \$ Mech. Room Receptacles	3 - #12
30	30 20 Conference Room East Receptacles 3 - #12		3 - #12	
31				
32		20		
33		20		
34		20	O Mechanical Room Receptacles 3	
35		20		
36		20	20 Service Panel Receptacle	
37		20	20 Exterior PGC Sign Lights	
38 - 60			Spare Spaces	

		All exposed	wiring in mi	 1	conduit, all	concealed wiring	shall be MC.
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PANEL SCHEDULE NOTES:

	LIGHTING FIXTURE SCHEDULE				
MARK	QTY	FIXTURE TYPE	MODEL		
A	15	2' x 4' LED Flat Panel	LITHONIA EPANL 24 40L 35k		
В	24	2' x 2' LED Flat Panel	LITHONIA EPANL 22 34L 35k		
С	3	1 x 4' LED Surface Mounted	LITHONIA SBL4LP835		
D	1	II" Round LED Surface Mount	LITHONIA FMLRL 1 I 14840 M4		
E	2	2' Integrated LED wall mount vanity light	LITHONIA FMVTSL 3000K		
F	1	4' Integrated LED wall mount vanity light	LITHONIA FMVTSL 3000K		
G	7	6" Round Recessed Downlight	LITHONIA WF6 LED 40K MVOLT w/New Construction Par		
Н	3	WDGE LED Architectural Wallpack	LITHONIA WDGE I LED 300K		
I	4	LED Site Lighting Wall Mounted	LITHONIA TWX2 LED ALO 40K MVOLT DDBTXD		
J	2	Linear Assymmetric Distributed Bronze Spot Light with LED source with integral driver. I 2" stem with knuckle	AMETRIX A04-S -A-4000-LED-40K- 20-b-AK 2		

	SYMBOL SCHEDULE - EMERGENCY LIGHTING			
SYMBOL	DESCRIPTION			
K\$ ⋈	NEW LED EXIT SIGN COMBO UNIT W/ BATTERY BACK UP AND REMOTE EXTERIOR HEAD, LITHONIA MODEL No. ECRLEDHO MG W/ ELALED WP M 2 OR APPROVED EQUAL			
ÎOÎ	NEW LED DOUBLE FACED EXIT SIGN WITH DIRECTIONAL CHEVRONS AND NI-MH BATTERY BACKUP, LITHONIA MODEL No. EXRG EL MG OR APPROVED EQUAL			
EM	NEW BATTERY BACK UP EMERGENCY LIGHT PACK, LITHONIA MODEL No. EU2C OR APPROVED EQUAL			

RECEPTACLE \$ SWITCH MOUNTING HEIGHTS

Office Receptacles and Telephone | 18"

All switches and other receptacles | 42"

GENERAL ELECTRICAL NOTES:


- I. FURNISH AND INSTALL SOLID COPPER CONDUCTORS AS SPECIFIED; NO ALUMINUM AND NO STRANDED. MC CABLE IS APPROVED FOR ALL HOME RUN CIRCUITS IF NEATLY INSTALLED.
- 2. ALL CONDUCTORS FOR 120V CIRCUITS OVER 100' IN LENGTH SHALL BE MINIMUM #10AWG. ALL CONDUCTORS FOR 120V CIRCUITS OVER 150' IN LENGTH SHALL BE MINIMUM #8AWG. CONTRACTOR IS RESPONSIBLE FOR VERIFICATION OF FINAL CIRCUIT LENGTHS AND CORRESPONDING WIRE SIZE TO ENSURE VOLTAGE DROP IS MAINTAINED WITHIN NEC LIMITS.
- 3. ALL WORK SHALL BE PERFORMED AS REQUIRED BY APPLICABLE SECTION OF THE NATIONAL ELECTRICAL CODE (NEC), LATEST EDITION, AND ALL GOVERNING UCC BUILDING CODES AND REGULATIONS.
- 4. PROVIDE GROUNDING AND BONDING FOR ELECTRICAL SYSTEMS. ELECTRICAL COMPONENTS, DEVICES AND ACCESSORIES SHALL BE LISTED AND LABELED AS DEFINED IN NFPA 70 AND COMPLY WITH UL 467 FOR GROUNDING AND BONDING MATERIALS AND EQUIPMENT. INSTALL INSULATED EQUIPMENT GROUNDING CONDUCTORS ALL FEEDERS AND BRACH CIRCUITS, LIGHTING CIRCUITS, RECEPTACLE CIRCUITS SINGLE PHASE MOTOR AND APPLIANCE BRANCH CIRCUITS, ARMORED AND METAL-CLAD CABLE RUNS AND AS REQUIRED BY NFPA 70.
- 5. PROVIDE ALL HANGERS AND SUPPORTS FOR ELECTRICAL SYSTEMS, INCLUDING STEEL SLOTTED SUPPORT SYSTEMS, CONDUIT AND CABLE SUPPORT DEVICES, SUPPORTS FOR CONDUCTORS IN VERTICAL CONDUIT. HANGERS AND SUPPORTS SHALL HAVE A FLAME RATING OF CLASS I AND BE SELF-EXTINGUISHING ACCORDING TO ASTM D 635.

LIGHTING GENERAL NOTES:

- I. FURNISH AND INSTALL NEW EPANL COMPATIBLE OCCUPANCY SENOR (WSXA) SWITCHES AND CEILING/SURFACE MOUNTED OCCUPANCY SENSORS (NCM-LARGE MOTION) AT LOCATIONS AS INDICATED ON ELECTRICAL FLOOR PLAN. FURNISH AND INSTALL EPANL COMPATIBLE WALL DIMMING SWITCHES (SPOD) AT LOCATIONS AS INDICATED ON ELECTRICAL FLOOR PLAN.
- 2. THE CONTRACTOR SHALL VERIFY DIMENSIONS PRIOR TO INSTALLATION. CONTRACTOR SHALL COORDINATE ALL WORK WITH OTHER TRADES TO PROVIDE A COMPLETE AND OPERABLE LIGHTING SYSTEM. CONTRACTOR SHALL COORDINATE LOCATION OF FIXTURES, DEVICES, ETC. WITH OTHER TRADES IN ORDER TO AVOID INTERFERENCES.
- 3. ALL WIRING SHALL BE TYPE "THHN/THHW" UNLESS OTHERWISE NOTED; MINIMUM WIRING SHALL BE #12. ALL WIRE SHALL BE COPPER. MINIMUM CONDUIT SIZE SHALL BE 3/4". SYSTEM AND EQUIPMENT GROUNDING CONTINUITY SHALL BE ASSURED AS REQUIRED BY APPLICABLE SECTIONS OF THE NEC.
- 4. ALL CIRCUIT PROTECTIVE DEVICES SHALL HAVE THE REQUIRED RATING INTERRUPTING CAPACITY EQUAL TO OR GREATER THAN THE AVAILABLE SHORT-CIRCUIT CURRENT AT ITS SUPPLY TERMINAL.
- 5. TYPICAL FIXTURE TAG "A" DENOTES FIXTURE TYPE TO BE CONNECTED TO NEW ELECTRICAL PANEL. PROVIDE ALL ACCESSORY LIGHTING CONTROLS AND MOUNTING HARDWARE AS REQUIRED FOR INSTALLATION OF NEW LIGHTING SYSTEMS.
- 6. FURNISH AND INSTALL NEW WEATHERPROOF DUSK TO DAWN ELECTRIC PHOTOCELL SENSOR FOR EXTERIOR LIGHTING CIRCUITRY AND FIXTURES AT LOCATIONS AS INDICATED ON ELECTRICAL FLOOR PLAN.

DATA / IT:

- I. FURNISH AND INSTALL EMT OR PVC CONDUIT IN WALL CAVITY AND/OR SLABS AS APPLICABLE. TERMINATE THE CONDUIT AND/OR CHASES INTO THE WORK BOXES. CONDUITS AND CHASES MAY TERMINATE ABOVE WALL ASSEMBLY OR TO DESIGNATED WORK ACCESS AREA.
- 2. INSTALL CAT6 CABLING FOR ALL IT AND PHONE LINES. PGC IS TO DESIGNATE LOCATIONS OF WHICH WORK BOXES ARE TO RECEIVE DATA OR PHONE PORT FACE PLATES. ALL CABLING HOME-RUNS ARE TO BE ROUTED APPROPRIATELY THROUGH CONDUITS AND CABLE TRAYS AND TERMINATED THROUGH A CHASE IN THE MECHANICAL ROOM WITH 10' SPARE CABLING (USED IN FINAL CONNECTIONS).
- 3. WHERE ADJACENT DATA PORTS ARE DENOTED PER THE DRAWINGS, DOUBLE PORTS ARE ALLOWABLE.
- 4. ALL DATA PORTS ARE TO BE LABELED WITH A NUMERICAL SYSTEM AND THE HOME-RUN CABLING IS TO BE LABELED CORRESPONDINGLY FOR FINAL CONNECTIONS.

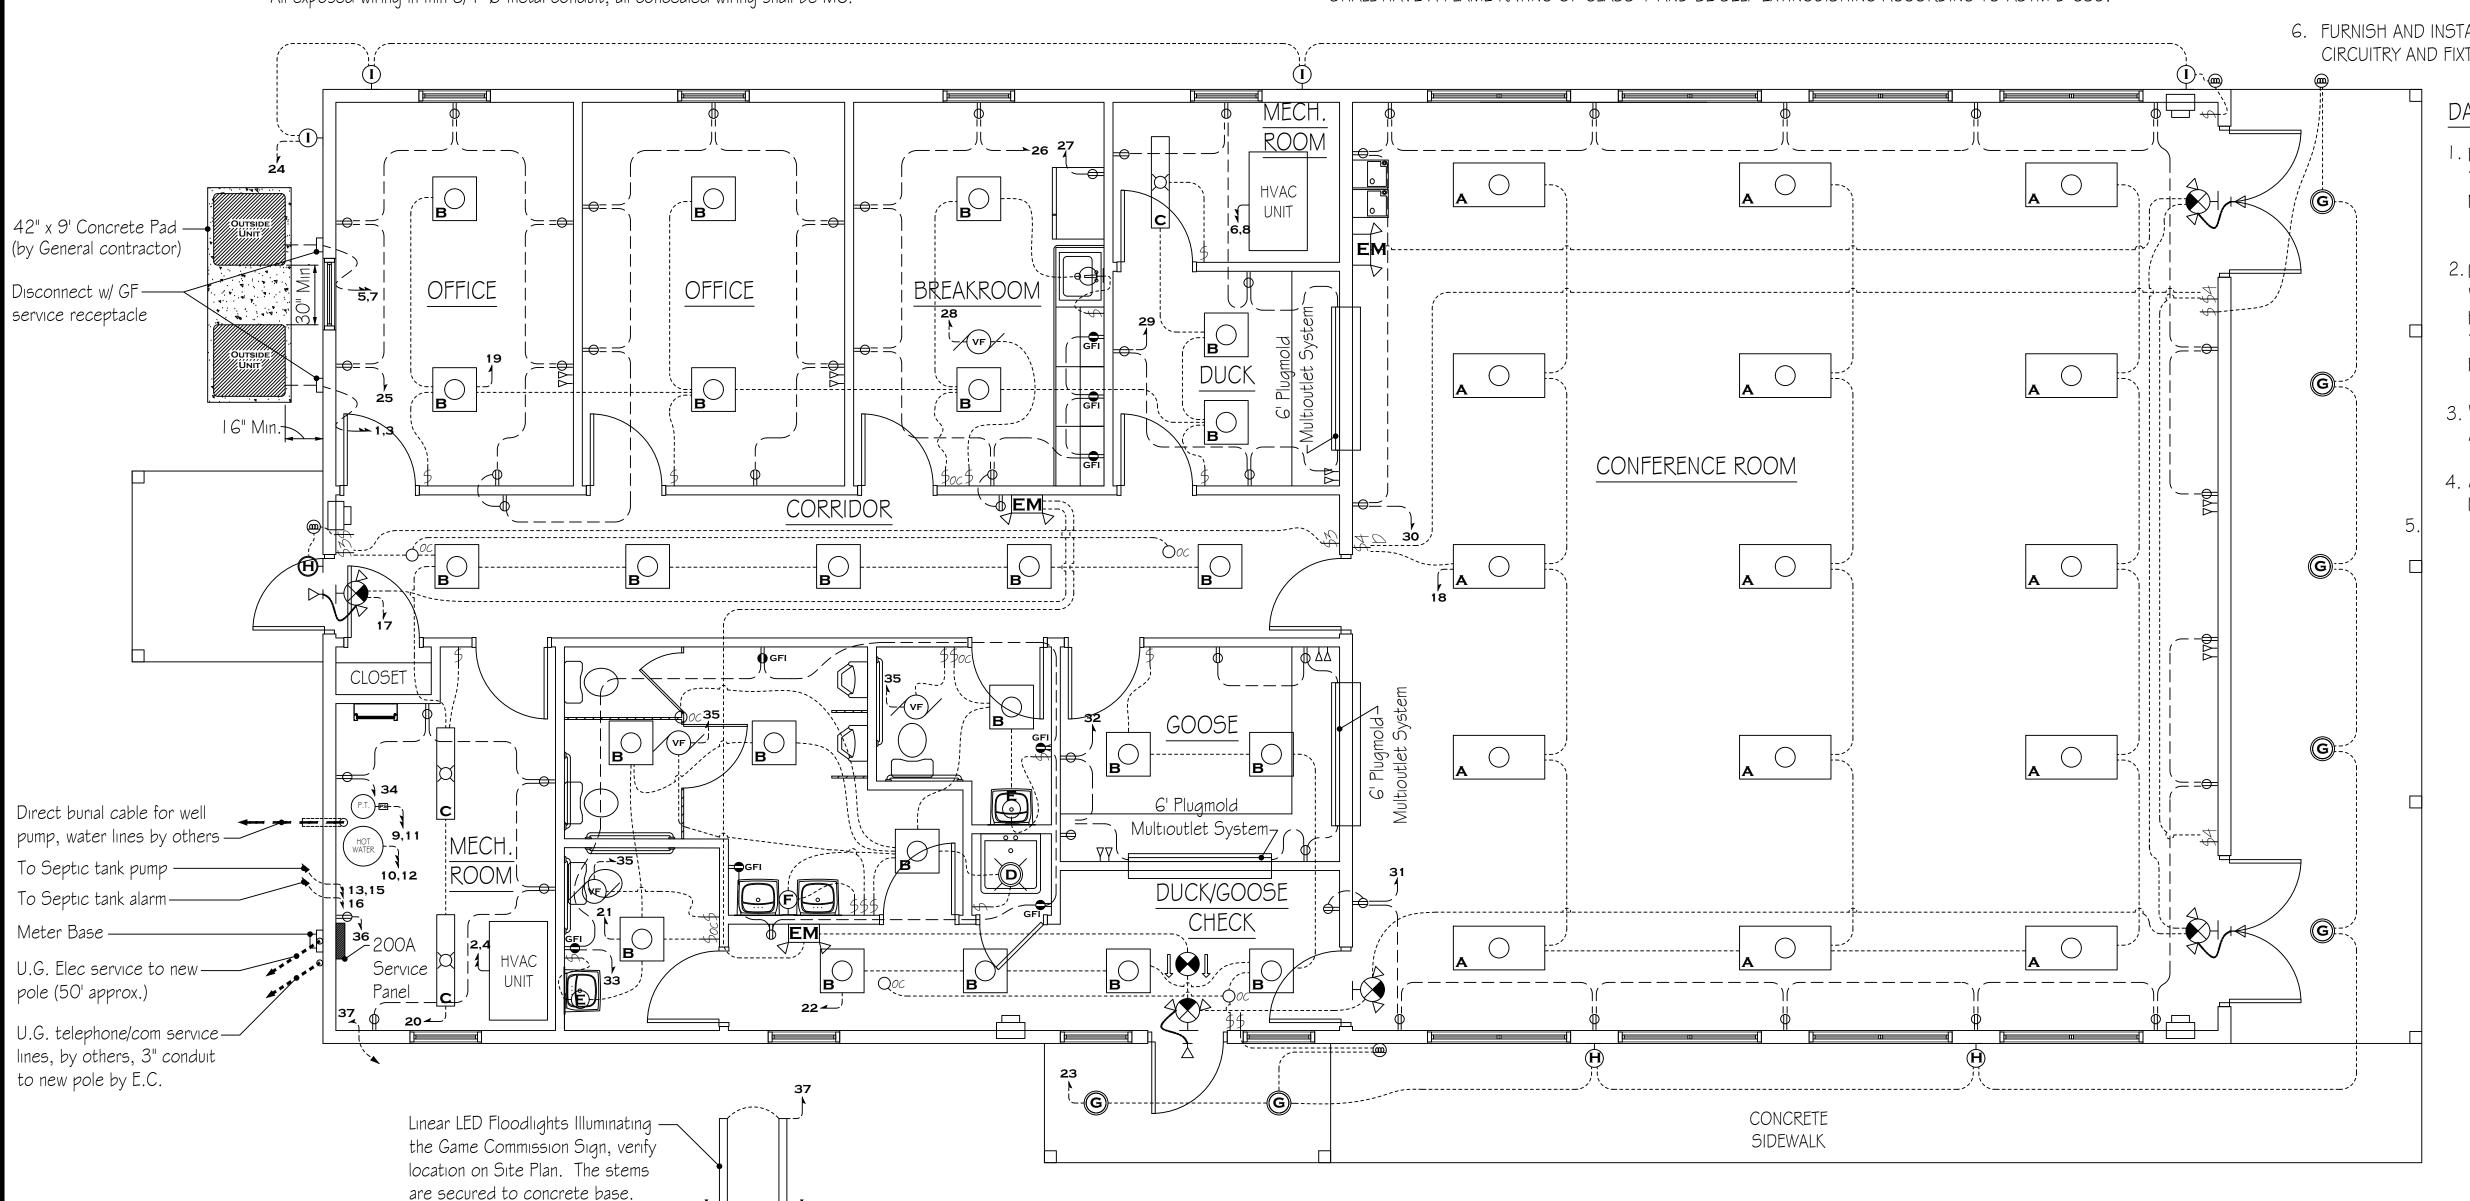

FIRST FLOOR PLAN - ELECTRICAL

SCALE: 1/4" = 1'-0"

ELECTRICAL WIRING SYMBOLS

Duplex GFI Receptacle

→ Telecommunications Outlet

\$000 Switch, Occupancy Sensor

Pressure Switch

Water PumpDusk to Dawn Photocell

₩ Exit \$ Emergency Egress Lighting

→ Home Run/Circuit #

w/back-up batteries

\$3 Switch, 3 Way

\$4 Switch, 4 Way

(vF) Exhaust Fan

⇒ Duplex Outlet⇒ Quad Outlet

Water Heater

Photo Cell

\$ Switch

PENNSYLVANIA GAME COMMISSION

STATE GAME LANDS #214 NORTH SHENANGO TWP. CRAWFORD CO.

NEW 40' x 80' WATERFOWL CHECK BUILDING

ELECTRICAL FLOOR PLAN, SCHEDULES & DETAILS

REVISIONS
PROJECT NO. PGC-214-21-02
DRAWN BY: CLOUSER/SPOTTS
DATE: 2/27/2023
SHEET NO. E-1