COMMONWEALTH OF PENNSYLVANIA DEPARTMENT OF MILITARY AND VETERANS' AFFAIRS ANNVILLE, PENNSYLVANIA

COVER SHEET G.1.1 PROJECT INFORMATION G.1.2

GENERAL CONSTRUCTION

_		•—••		_	-	•	<u> </u>	•		_		-	
	VII –	DW	GS										
	v 1 🗠		\mathbf{c}										

C.1.0 C.2.0 C.2.1 C.3.0 C.3.1	EXISTING SITE PLAN ENERGY UPGRADES SITE PLAN FENCE DETAILS E&S PLAN E&S NOTES AND DETAILS
ARCHITE	CTURAL DWGS.
AD.1.0	DEMO PLAN - AREA 'B'
AD.1.1	DEMO CLG PLAN - AREA 'B'
A.1.1	FLOOR PLAN - AREA 'B'
A.1.2	CEILING PLAN - AREA 'B'
A.2.1	SCHEDULES & DETAILS
A.3.1	DETAILS
A.3.2	ELEVATIONS & DETAILS
STRUCTU	JRAL DWGS.

UCTURAL DWGS. S.1.1 SECTIONS & DETAILS

JOSH SHAPIRO, GOVERNOR MAJ. GEN. MARK J. SCHINDLER, THE ADJUTANT GENERAL

PROJECT NO.: 420591(88821) BLDG. 11-89 TISA ENERGY UPGRADES ANNVILLE, LEBANON COUNTY, PENNSYLVANIA

DESIGN PROFESSIONALS: OFFICE OF FACILITIES AND ENGINEERING BUREAU OF DESIGN AND PROJECT MANAGEMENT BUILBING 0-10, CHAPEL ROAD, FORT INDIANTOWN GAP ANNVILLE, LEBANON COUNTY, PENNSYLVANIA

INDEX TO DRAWINGS

HVAC CONSTRUCTION

HVAC DWO	S.
H.0.1	SYMBOLS & NOTES
H.1.0	DEMO PLAN - MECHANICAL
H.1.1	FLOOR PLAN - MECHANICAL
H.1.2	PART PLAN - MECHANICAL
H.3.1	SCHEMATIC PIPING
H.3.2	SECTIONS - MECHANICAL
H.3.3	SECTIONS - MECHANICAL
H.3.4	SECTIONS - MECHANICAL
H.4.1	SCHEDULES - MECHANICAL
H.4.2	DETAILS - MECHANICAL
H.5.1	SITE PLAN - MECHANICAL
H.5.2	SITE DETAILS - MECHANICAL
H.5.3	WELL FIELD LAYOUT

PLUMBING CONSTRUCTION

PLUMBING	DWGS.
P.1.0	DEMO PLAN - PLUMBING
P.1.1	OVERALL PLAN - PLUMBIN


P.1.2 PLUMBING DETAILS


FIRE PROTECTION DWGS. FP.1.1 FP - ROOF SYSTEM

FP.1.Z	FP - CEILING SYSTEM
FP.1.3	FP - IN-RACK SYSTEM
FP.1.4	FP - DETAILS

ELECTRICAL CONSTRUCTION

ELECTRICA	AL DWGS.
E.0.1	LIGHTING DEMOLITION PLAN
E.0.2	POWER DEMOLITION PLAN
E.0.3	REFRIGERATION DEMOLITION PLAN
E.1.1	LIGHTING PLAN
E.1.2	POWER PLAN
E.1.3	REFRIGERATION PLAN
E.2.1	RISER DIAGRAM
E.3.1	PANEL SCHEDULES
E.4.1	DETAILS
ES.5.1	SOLAR PLOT PLAN
ES.5.2	SOLAR ONE-LINE
ES.5.3	SOLAR MOUNTING DETAILS
ES.5.4	CONDUIT DETAILS
ES.5.5	SOLAR FIELD DETAILS
ES.5.6	SOLAR FIELD NOTES

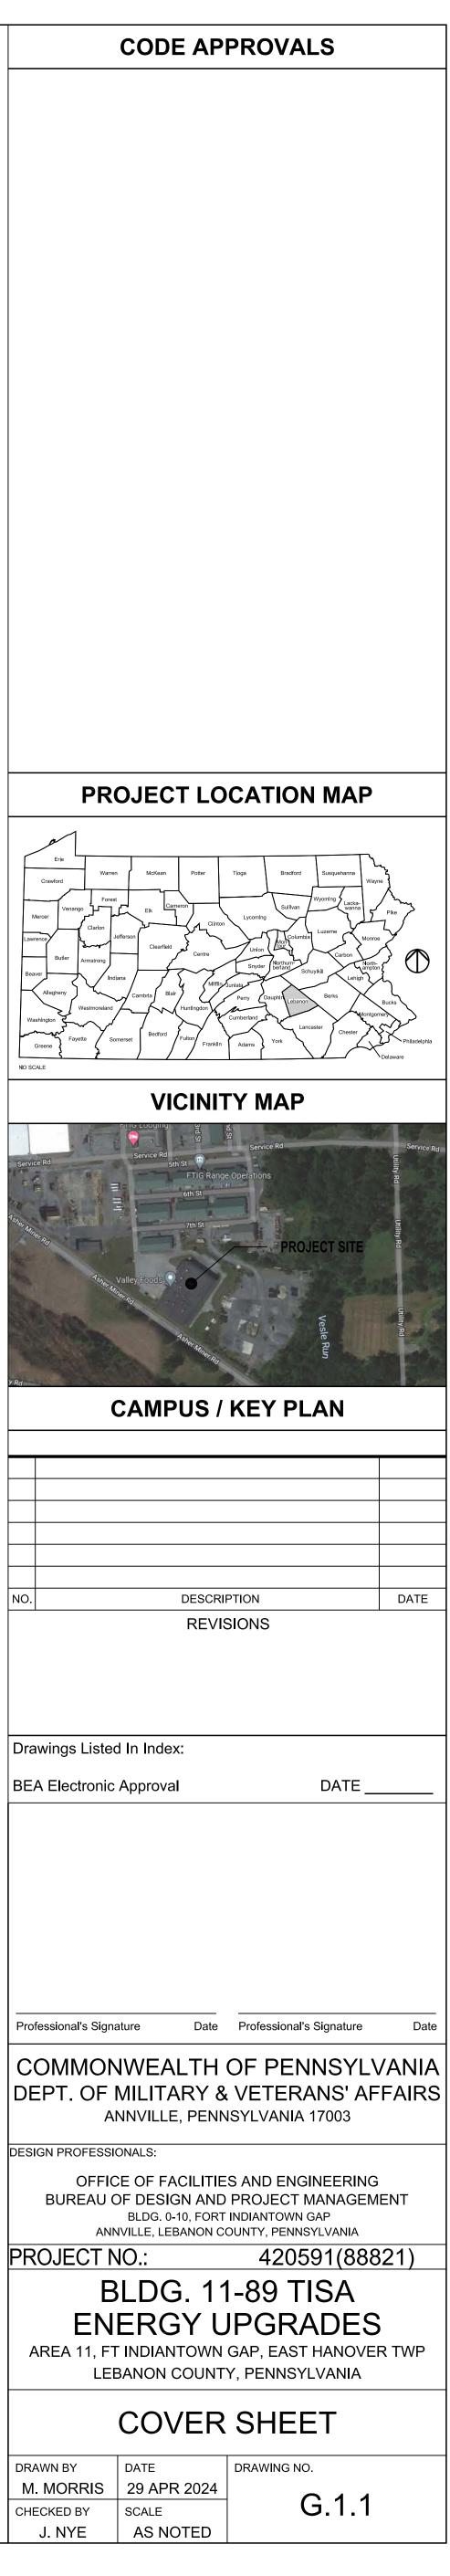

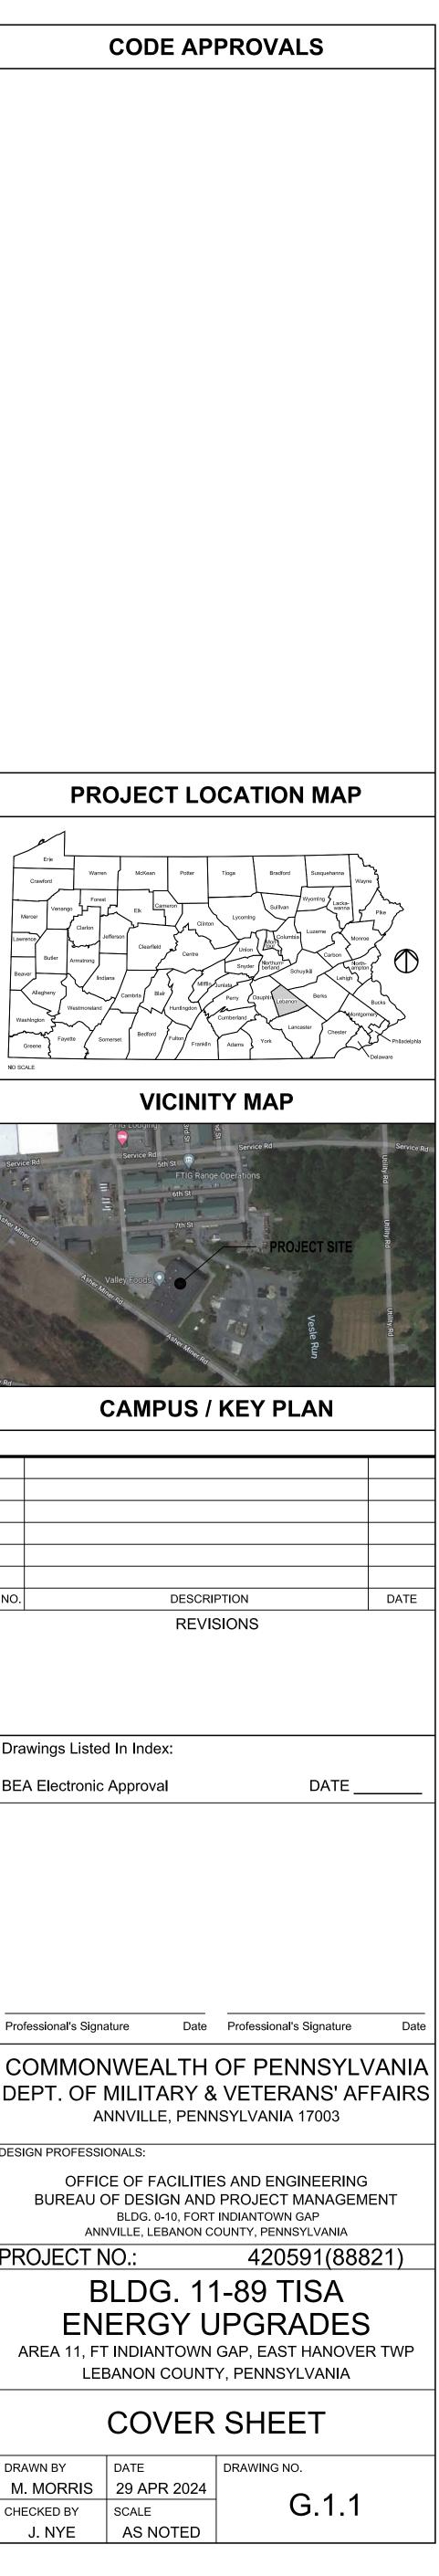


APPLICABLE CODES TISA - BUILDING 11-89

UNIFORM CONSTRUCTION CODE, 2018 INTERNATIONAL BUILDING CODE, 2018 INTERNATIONAL MECHANICAL CODE, 2018 INTERNATIONAL PLUMBING CODE, 2023 ICC ELECTRICAL CODE, 2018 INTERNATIONAL ENERGY CONSERVATION CODE, ICC/ANSI A117.1-2017.

	ABBREV		J
A.B.V.	ABOVE		
4.F.F.	ABOVE FINISHED FLOOR	HORZ.	HORIZONTAL
ACT.	ACOUSTICAL TILE	H.B.	HOSE BIB
ADJ.	ADJUSTABLE	I.D.	INSIDE DIAMETER
4.C.	AIR CONDITIONING	INSUL.	INSULATION OR INSULATED
ALT.	ALTERNATE	INV.	INVERT
ALUM.	ALUMINUM	LAM.	LAMINATED
\.В. -	ANCHOR BOLT	L.	LENGTH
0		M.H.	MAN HOLE
3.F.F.	BELOW FINISHED FLOOR	MFR.	MANUFACTURER
3.G.	BELOW GRADE	M.O.	MASONRY OPENING
8.M.	BENCH MARK	MAT.	MATERIAL
RG.	BRIDGING OR BEARING	MAX.	MAXIMUM
D.	BOARD	M.C.	
OT.	BOTTOM	M.D.F.	MEDIUM DENSITY FIBERBOARD
L.		MTL. M.T.	
LDG.	BUILDING	MIN.	
AB.	CABINET	MIN. MLDG.	MINIMUM MOLDING
PT.	CARPET CAST IRON	NOM.	NOMINAL
		N.I.C.	
.B. LG.	CATCH BASIN CEILING	N.T.S.	NOT TO SCALE
/C	CENTER TO CENTER	NO.	NUMBER
	CENTER TO CENTER	0.C.	ON CENTER
ED		OPG.	
ER. .T.	CERAMIC CERAMIC TILE	0.W.	OPENING OPEN WEB
	CLEAN OUT	OPP.	OPPOSITE
LR.	CLEAR	O.S.B.	ORIENTED STRAND BOARD
	COLORED CONCRETE MASONRY UNIT	0.0.D.	OUTSIDE DIAMETER
OL.	COLUMN	PND.	PAINTED
CONC.	CONCRETE	PLAS.	PLASTER
CMU.	CONCRETE MASONRY UNIT	PLAM	PLASTIC LAMINATE
CONT.	CONTINUOUS	PL.	PLATE
).J.	CONTROL JOINT	P.C.	PLUMBING CONTRACTOR
TR.	COUNTER	P.S.I.	POUNDS PER SQUARE INCH
ик.	DECK	P.T.	PRESSURE TREATED
)TL.	DETAIL	P.S.I.	POUNDS PER SQUARE INCH
IM.	DIMENSION	Q.T.	QUARRY TILE
)R.	DOOR	REINF	REINFORCING
DN.	DOWN	REQ'D	REQUIRED
).S.	DOWN SPOUT	RET.	RETARDANT
DWG.	DRAWING	R.A.	RETURN AIR
A.	EACH	RM.	ROOM
ELEC.	ELECTRICAL	R.O.	ROUGH OPENING
E.C.	ELECTRICAL CONTRACTOR	SECT.	SECTION
.W.C.	ELECTRIC WATER COOLER	SCHED.	SCHEDULE
EL. ELEV.	ELEVATION	SIM.	SIMILAR
Q.	EQUAL	s.c.	SOLID CORE
EX. EXST.	EXISTING	S.C.W.	SOLID CORE WOOD
EXP.	EXPOSED OR EXPANSION	SPEC.	SPECIFICATION
EXT.	EXTERIOR	S.B.	SPLASH BLOCK
E.I.F.S.	EXTERIOR INSULATED FINISHING SYSTEM	S.F.C.M.U.	SPLIT-FACE CONCRETE MASONRY UN
.F.S.	EXTERIOR FINISHING SYSTEM	S.F. SQ.FT.	SQUARE FOOT
R.P.	FIBERGLASS REINFORCED PANEL	S.S.	STAINLESS STEEL
IN.	FINISH	STD.	STANDARD
.C.	FINISHED CEILING	STL.	STEEL
⁻ .F.	FINISHED FLOOR	STRUCT.	STRUCTURAL
.G.	FINISHED GRADE	TEMP.	TEMPERED OR TEMPERATURE
.E.	FIRE EXTINGUISHER	TH.	THICK OR THICKNESS
.E.C.	FIRE EXTINGUISHER CABINET	T&G	TONGUE AND GROOVE
.R.	FIRE RATED	T.O.F.	TOP OF FOOTING
LR.	FLOOR	Т.О.М.	TOP OF MASONRY
.D.	FLOOR DRAIN	T.O.P.	TOP OF PLATE
T.	FOOT OR FEET	T.O.S.	TOP OF STEEL
TG.	FOOTING	TYP.	TYPICAL
.S.	FULL SIZE	U.N.O.	UNLESS NOTED OTHERWISE
9.C.	GENERAL CONTRACTOR	V.B.	VAPOR BARRIER
SL.	GLASS OR GLAZING	VAR.	VARIES
G.F.C.M.U.	GROUND FACE CONCRETE MASONRY UNIT	VERT.	
SYP.	GYPSUM	V.I.F.	
G.W.B.	GYPSUM WALL BOARD	V.C.W.	
I/C	HANDICAP	V.C.T.	VINYL COMPOSITION TILE
IDWR.	HARDWARE	V.C.B.	VINYL COVE BASE
I.V.A.C.	HEATING, VENTILATION & AIR CONDITIONING	W.W.F.	WELDED WIRE FABRIC
IGT.	HEIGHT	W.	WIDTH
I.C.	HOLLOW CORE	WIN.	WINDOW
I.C.M.	HOLLOW CORE MASONITE	w/	WITH
I.C.W.	HOLLOW CORE WOOD	w/o	WITHOUT
1.M.	HOLLOW METAL	WD.	WOOD
		W.I.	WROUGHT IRON

ARCHITECTURAL LEGEND					
MARK	DESCRIPTION				
? 101	DENOTES ROOM NAME AND NUMBER				
A	DENOTES WALL TYPES				
	DENOTES DOOR NUMBER				
A	DENOTES WINDOW TYPE				
X	DENOTES EXTERIOR ELEVATION				
A.X.X	DENOTES BUILDING / WALL SECTION				
X	DENOTES DETAILS AND LARGE SCALE PLANS				

LEGEND	OF MATERIALS
	BATT INSULATION
	BRICK
	CONCRETE
	CONCRETE BLOCK
	CRUSHED STONE
	EARTH
	FINISHED WOOD
	PLYWOOD
	RIGID INSULATION
	STEEL LARGE SCALE
I J	STEEL SMALL SCALE
	WOOD BLOCKING
	WOOD ROUGH

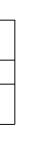

DRAWING INTERPRETATION


DETAILS INDICATED ON THE DRAWINGS, BOTH TYPICAL (TYP.) AND SPECIFIC, SHALL APPLY TO ALL SITUATIONS OCCURRING ON THE PROJECT THAT ARE THE SAME OR SIMILAR TO THOSE SPECIFICALLY DETAILED. THE APPLICABILITY OF THE DETAIL TO ITS LOCATION ON THE PLANS CAN BE DETERMINED BY THE TITLE OF THE DETAIL. SUCH DETAILS SHALL APPLY WHETHER OR NOT THEY ARE KEYED AT EACH LOCATION. DECISIONS REGARDING THE APPLICABILITY OF DETAILS SHOWN SHALL BE DETERMINED BY THE GOVERNMENT DESIGN PROFESSIONAL AND/OR THE GOVERNMENT CONSTRUCTION MANAGEMENT SPECIALIST.

GENERAL NOTES

- CONTRACTOR SHALL VERIFY FIELD CONDITIONS AND DIMENSIONS AND REPORT DISCREPANCIES TO GOVERNMENT DESIGN PROFESSIONAL PRIOR TO COMMENCEMENT OF WORK.
- EXTERIOR DIMENSIONS SHOWN ON DRAWINGS ARE FINISHED FACE TO FINISHED FACE, UNLESS DEPICTED OTHERWISE.
- INTERIOR DIMENSIONS SHOWN ON DRAWINGS ARE CENTER OF

WALL TO CENTER OF WALL, UNLESS DEPICTED OTHERWISE.

- 4. DETAILS ARE TYPICAL AND SHOW COMMON PRACTICE. CONTRACTOR SHALL INCORPORATE THESE DETAILS INTO THE PROJECT AT APPROPRIATE LOCATIONS WHERE CONDITIONS ARE SIMILAR AND WHETHER SPECIFICALLY INDICATED OR NOT.
- DRAWINGS DEPICT COMMON PRACTICES AND ARE DIAGRAMMATIC, CONTRACTOR SHALL BE RESPONSIBLE FOR THE INSTALLATION OF ALL NECESSARY COMPONENTS NEEDED FOR A COMPLETE AND FUNCTIONAL FACILITY.
- CONTRACTOR SHALL BE RESPONSIBLE FOR FOLLOWING ALL APPLICABLE CODE REGULATIONS. ASPECTS NOT DETAILED WITHIN THE DESIGN DOCUMENTS SHALL BE INCORPORATED AS NECESSARY TO MEET ALL GOVERNING CODE REQUIREMENTS.
- EQUIPMENT AND MATERIALS DESIGNATED AS "NO SUBSTITUTIONS" ARE FORT INDIANTOWN GAP STANDARDS AND SHALL BE PROVIDED AS DETAILED ON DRAWINGS AND OUTLINED WITHIN PROJECT SPECIFICATIONS.
- GENERAL ("PRIME") CONTRACTOR IS RESPONSIBLE FOR COORDINATION OF WORK WITH THAT OF ALL OTHER TRADES.
- THE TERM "PROVIDE", AS USED IN THE SPECIFICATIONS AND ON THE DRAWINGS, SHALL BE UNDERSTOOD TO MEAN "THE CONTRACTOR SHALL FURNISH AND INSTALL, COMPLETE AND OPERATIONAL, WITH ALL REQUIRED HARDWARE, ACCESSORIES AND APPURTENANCES." UNLESS INDICATED OTHERWISE, THIS SHALL ALSO INCLUDE ALL ASSOCIATED POWER AND/OR SIGNAL WIRING REQUIRED FOR ELECTRICAL SYSTEMS FURNISHED UNDER THIS CONTRACT.

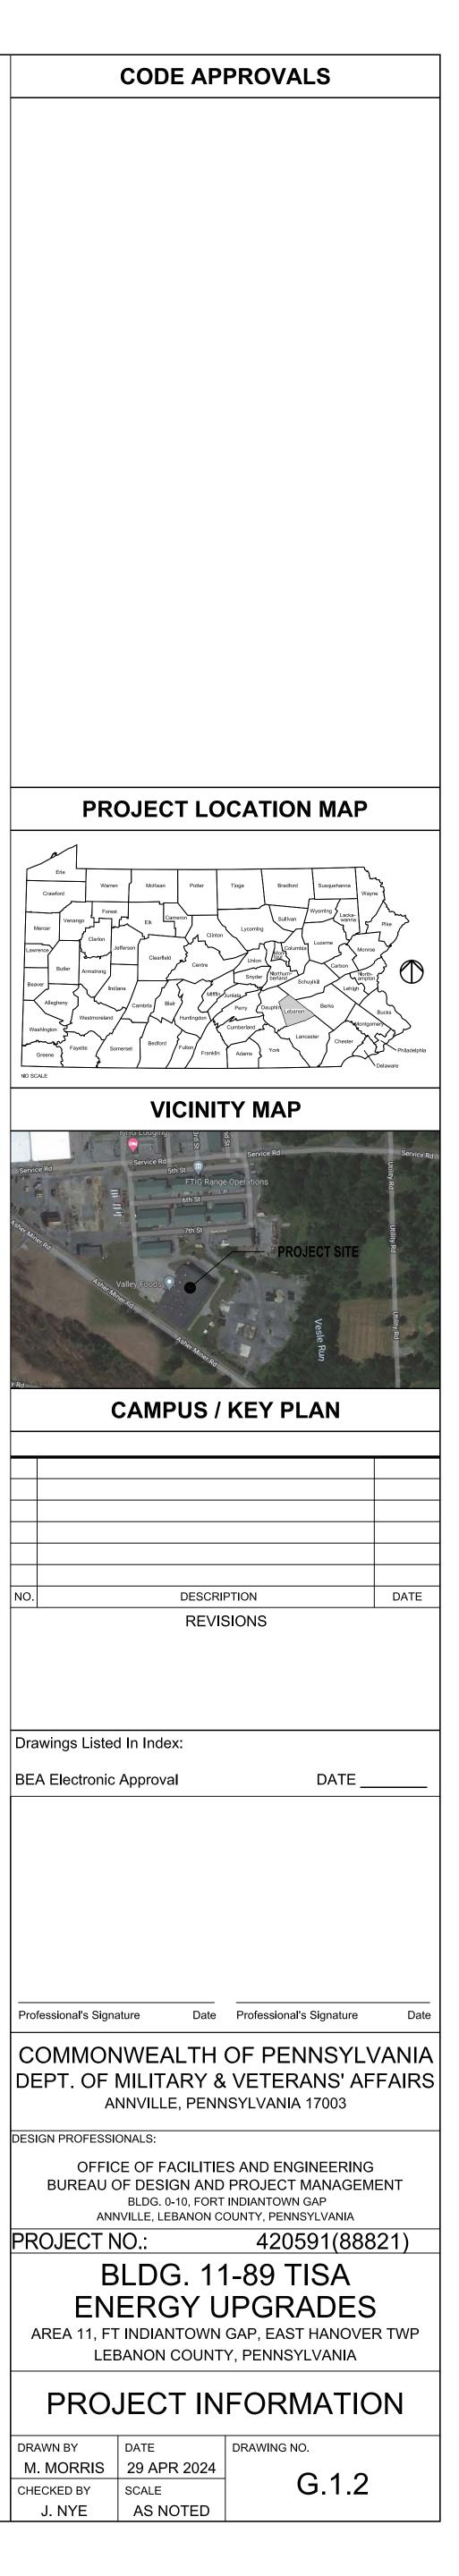


NO SCALE

NO.

DRAWN BY


CHECKED BY

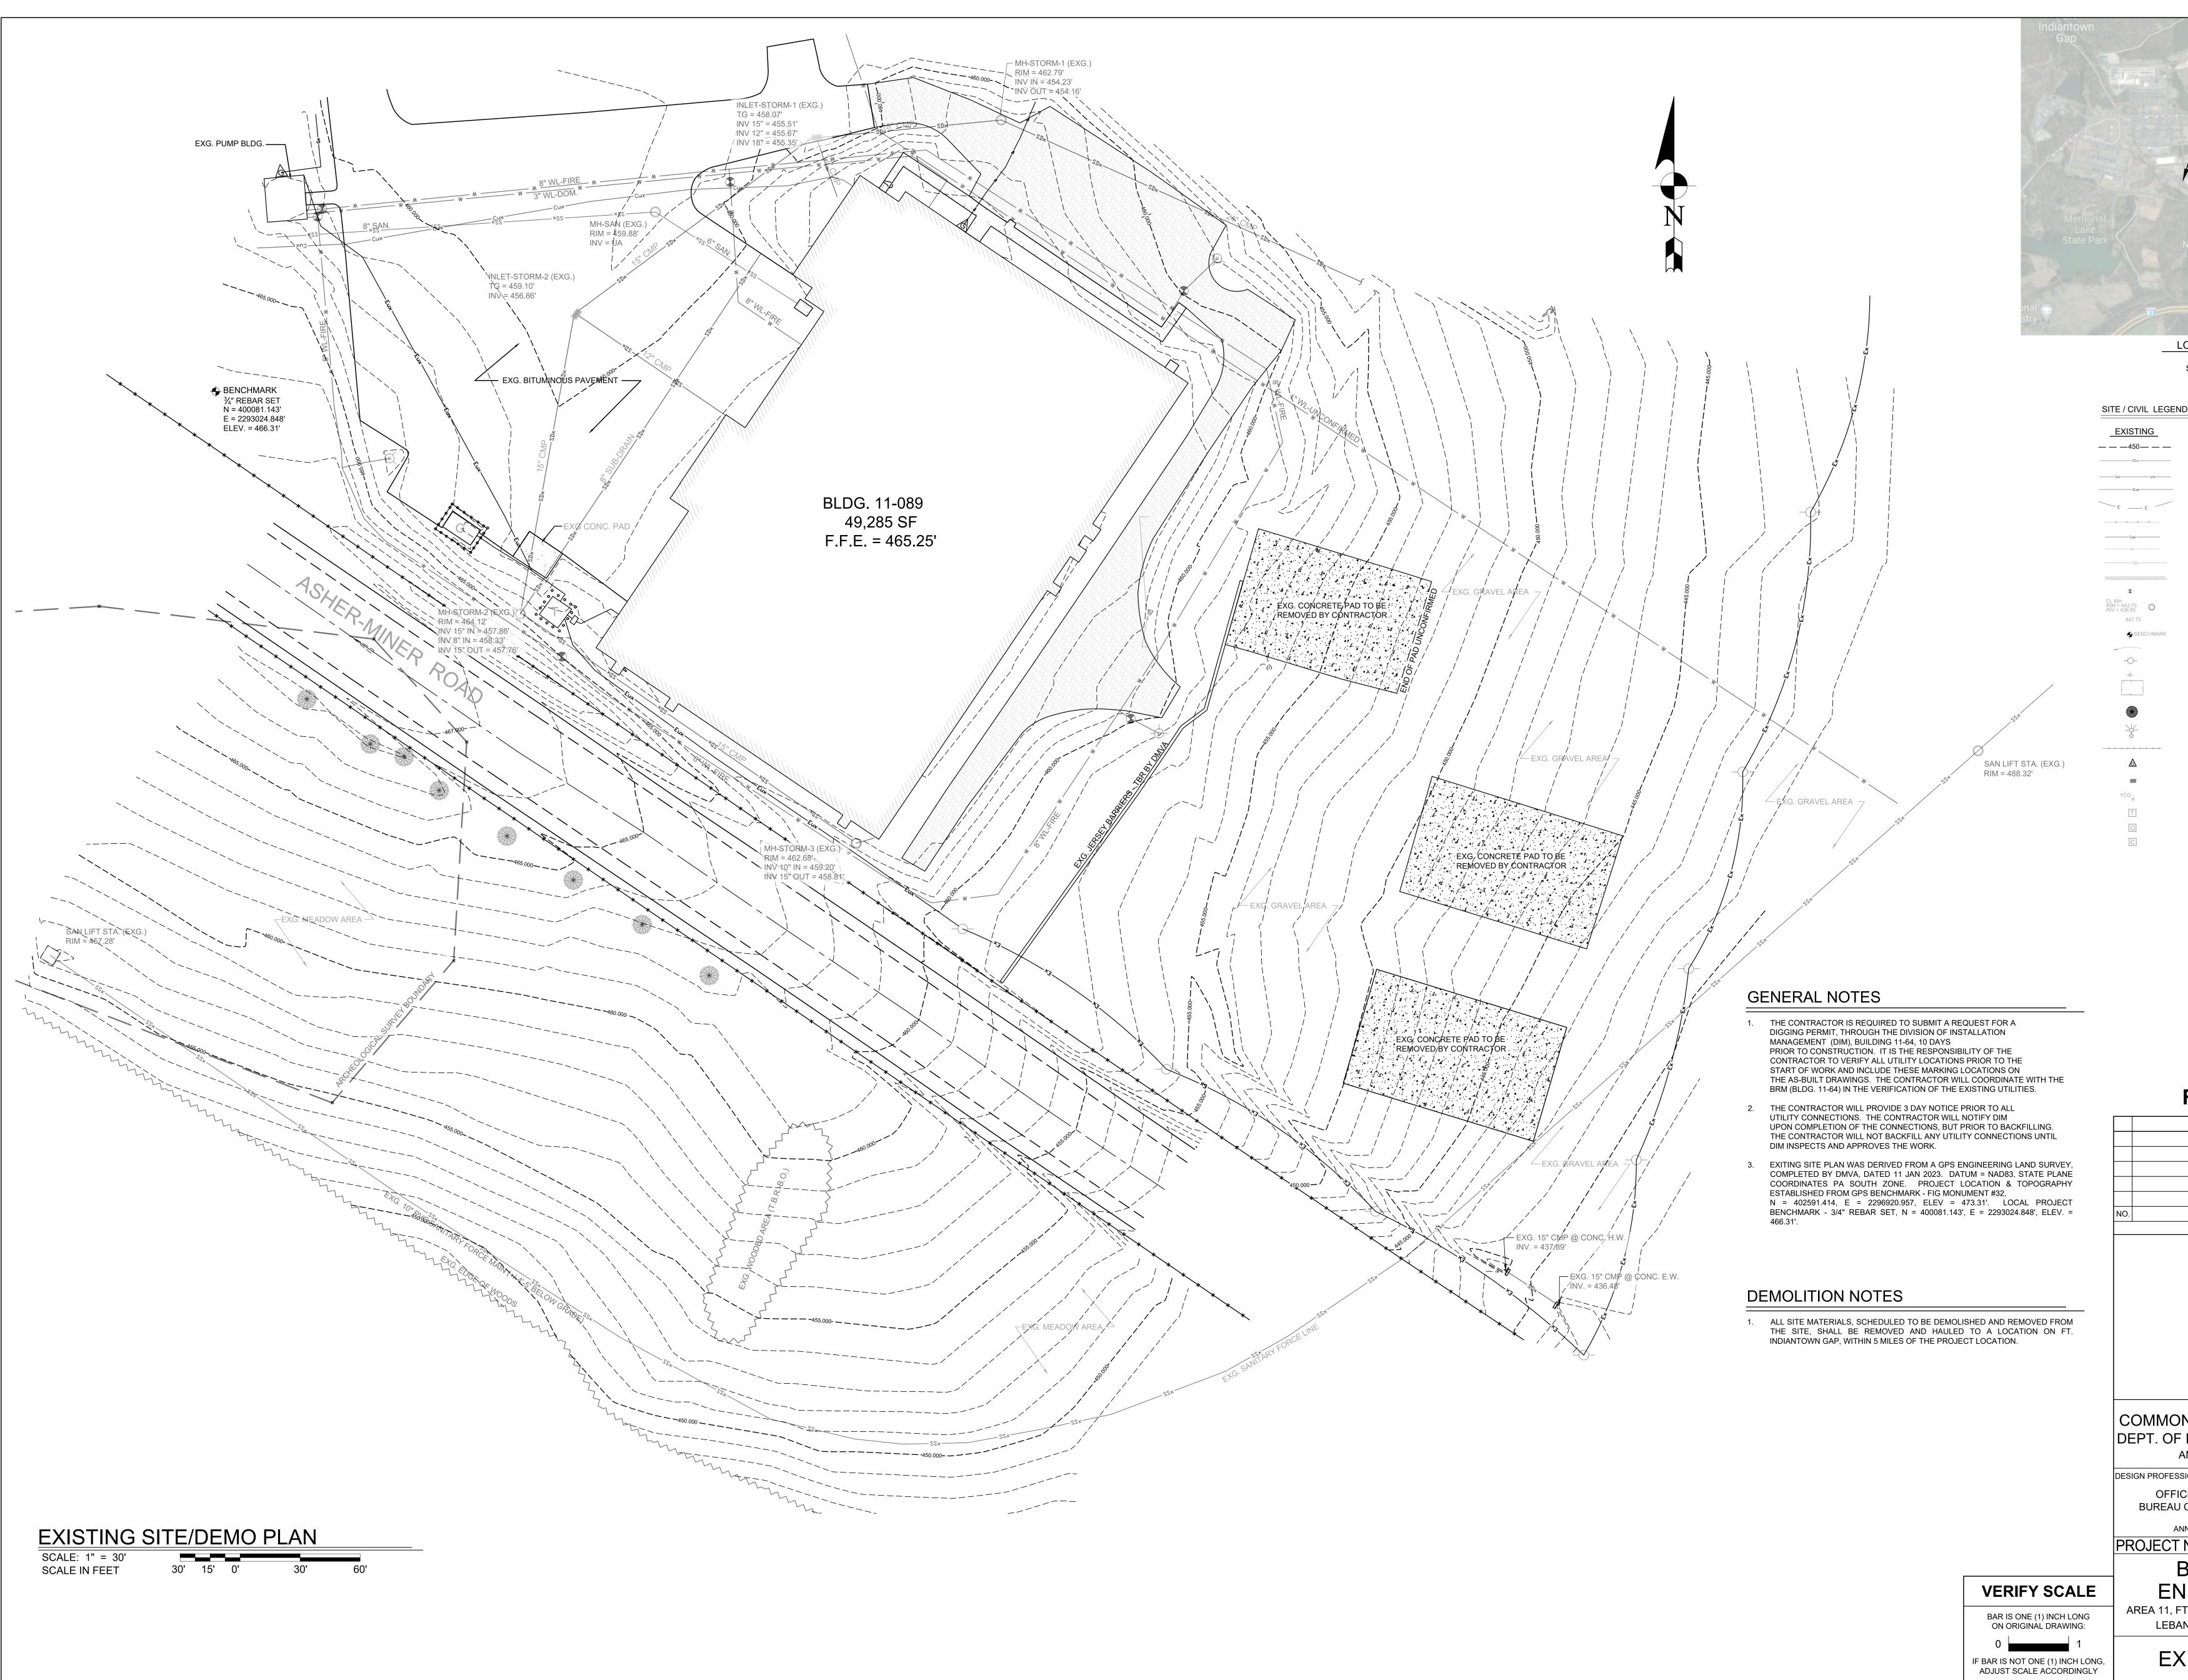


			and a second
- The state of the		Fort Indiantown Ga	ID
	PROJECT		0
	PROJECT	SITE	Sec.
A			
			~
	Indiantown Gap		-
	Indiantown Gap National Cemetery		
	NO		12
	LOCATION MAP 1" = 2,000'		
	SCALE IN FEET		
CIVIL LEGE	ND		
<u>ISTING</u> -450— — —	[450]	CONTOUR LINE	
	W W W W	SANITARY SEWER WATER LINE ELECTRIC - UNDERGROUND	
E		ELECTRIC - OVERHEAD	
х х х		FENCELINE COMMUNICATION - UNDERGROUN NATURAL GAS	D
SD×	SD 70000000000000000000000000000000	STORM SEWER EROSION FILTER SOCK	
2 13.70 O 6.85 O	\$ CL MH RIM = 443.70 INV = 436.85	WATER VALVE MANHOLE	
447.75	447.75	SPOT ELEVATION BENCHMARK ELEVATION	
- O	-O- -Ø-	FLOW ARROW UTILITY POLE FIRE HAYDRANT	
		CONCRETE HATCH	
¥.	_¥-	TREE POLE MOUNTED AREA LIGHTING	
 A	ــــــــــــــــــــــــــــــــــــــ	PENNDOT STANDARD GUIDE RAIL NATURAL GAS VALVE/METER	
	YCO °	STORM INLET SANITARY YARD CLEAN OUT	
T G	T G	ELECTRICAL TRANSFORMER W/ VA	JULT
С	C E	COMMUNICATIONS MANHOLE	
	(
	A1	BOLLARD GEOTHERMAL WELL IDENTIFICATIO	N
	0		ИС
	A1 TW MWO-1 MWM-1 MWI-1	GEOTHERMAL WELL IDENTIFICATION GEOTHERMAL TEST WELL MONITORING WELL OUTER LOOP MONITORING WELL MIDDLE LOOP MONITORING WELL INNER LOOP	N
	A1 TW MWO-1 MWM-1	GEOTHERMAL WELL IDENTIFICATION GEOTHERMAL TEST WELL MONITORING WELL OUTER LOOP MONITORING WELL MIDDLE LOOP MONITORING WELL INNER LOOP	N
	A1 TW MWO-1 MWM-1 MWI-1	GEOTHERMAL WELL IDENTIFICATION GEOTHERMAL TEST WELL MONITORING WELL OUTER LOOP MONITORING WELL MIDDLE LOOP MONITORING WELL INNER LOOP	
	A1 TW MWO-1 MWM-1 MWI-1	GEOTHERMAL WELL IDENTIFICATION GEOTHERMAL TEST WELL MONITORING WELL OUTER LOOP MONITORING WELL MIDDLE LOOP MONITORING WELL INNER LOOP	
	A1 TW MWO-1 MWM-1 MWI-1	GEOTHERMAL WELL IDENTIFICATION GEOTHERMAL TEST WELL MONITORING WELL OUTER LOOP MONITORING WELL INNER LOOP MONITORING WELL INNER LOOP	
	A1 TW MWO-1 MWI-1 MWI-1 MWI-1 DESCRIP REVISIO	GEOTHERMAL WELL IDENTIFICATION GEOTHERMAL TEST WELL MONITORING WELL OUTER LOOP MONITORING WELL INNER LOOP MONITORING WELL INNER LOOP	
COMMC	A1 TW MW0-1 MWI-1 MWI-1 FINAL DE DESCRIP REVISION Professional's Signatu	GEOTHERMAL WELL IDENTIFICATION GEOTHERMAL TEST WELL MONITORING WELL MIDDLE LOOP MONITORING WELL INNER LOOP	DATE
	A1 TW MW0-1 MWW-1 MWI-1 MWI-1 MWI-1 MWI-1	GEOTHERMAL WELL IDENTIFICATION GEOTHERMAL TEST WELL MONITORING WELL MIDDLE LOOP MONITORING WELL MIDDLE LOOP MONITORING WELL INNER LOOP	DATE
COMMC EPT. OI SIGN PROFE OFF BUREA	A1 TW MW0-1 MWI-1	GEOTHERMAL WELL IDENTIFICATION GEOTHERMAL TEST WELL MONITORING WELL OUTER LOOP MONITORING WELL INNER LOOP MONITORING WELL INNER LOOP MONITORING WELL INNER LOOP TION DIS TION DNS TION DNS TION DATE OF PENNSYLW /ETERAN'S AF YLVANIA 17003	
COMMC EPT. OI SIGN PROFE OFF BUREA	A1 TW MW0-1 MWM-1 MWI-1 MWI-1 MWI-1 MWI-1 MWI-1 MWI-1 MUI-1	GEOTHERMAL WELL IDENTIFICATION GEOTHERMAL TEST WELL MONITORING WELL OUTER LOOP MONITORING WELL INNER LOOP ESSIGN ESSIGN TION DNS FPENNSYLVA /ETERAN'S AF YLVANIA 17003 AND ENGINEERING ROJECT MANAGEMI DIANTOWN GAP YLVANIA 17003	
COMMO EPT. O SIGN PROFE OFF BUREA ROJEC ROJEC	A1 TW MW0-1 MWH-1 MWI-1	GEOTHERMAL WELL IDENTIFICATION GEOTHERMAL TEST WELL MONITORING WELL OUTER LOOP MONITORING WELL MIDDLE LOOP MONITORING WELL INNER LOOP SESIGN SESIGN SIGN SIGN SIGN SIGN SIGN SIGN SIGN	YANIA FAIRS
COMMO EPT. OI SIGN PROFE OFF BUREAU ROJEC	A1 TW MW0-1 MWH-1 MWI-1	GEOTHERMAL WELL IDENTIFICATION GEOTHERMAL TEST WELL MONITORING WELL OUTER LOOP MONITORING WELL MIDDLE LOOP MONITORING WELL INNER LOOP SESIGN ESSIGN INNER LOOP TION DNS TION DNS TION DNS TION DNS TION DNS TION DNS TION DNS TION DATE SESIGN AND ENGINEERING ROJECT MANAGEMI DIANTOWN GAP NTY, PENNSYLVANIA 420591 (888 AP, EAST HANOVER INNSYLVANIA 17003	YANIA FAIRS
COMMO EPT. OI SIGN PROFE OFF BUREAU ROJEC ROJEC	A1 TW MW0-1 MWH-1	GEOTHERMAL WELL IDENTIFICATION GEOTHERMAL TEST WELL MONITORING WELL OUTER LOOP MONITORING WELL MIDDLE LOOP MONITORING WELL INNER LOOP SESIGN ESSIGN INNER LOOP TION DNS TION DNS TION DNS TION DNS TION DNS TION DNS TION DNS TION DATE SESIGN AND ENGINEERING ROJECT MANAGEMI DIANTOWN GAP NTY, PENNSYLVANIA 420591 (888 AP, EAST HANOVER INNSYLVANIA 17003	YANIA FAIRS


CONTRACTOR SHALL FIELD VERIFY ALL DIMENSIONS.

VARIANCE FROM CONTRACT DOCUMENTS NOT PERMITTED WITHOUT BUREAU OF ENGINEERING AND ARCHITECTURE APPROVAL.

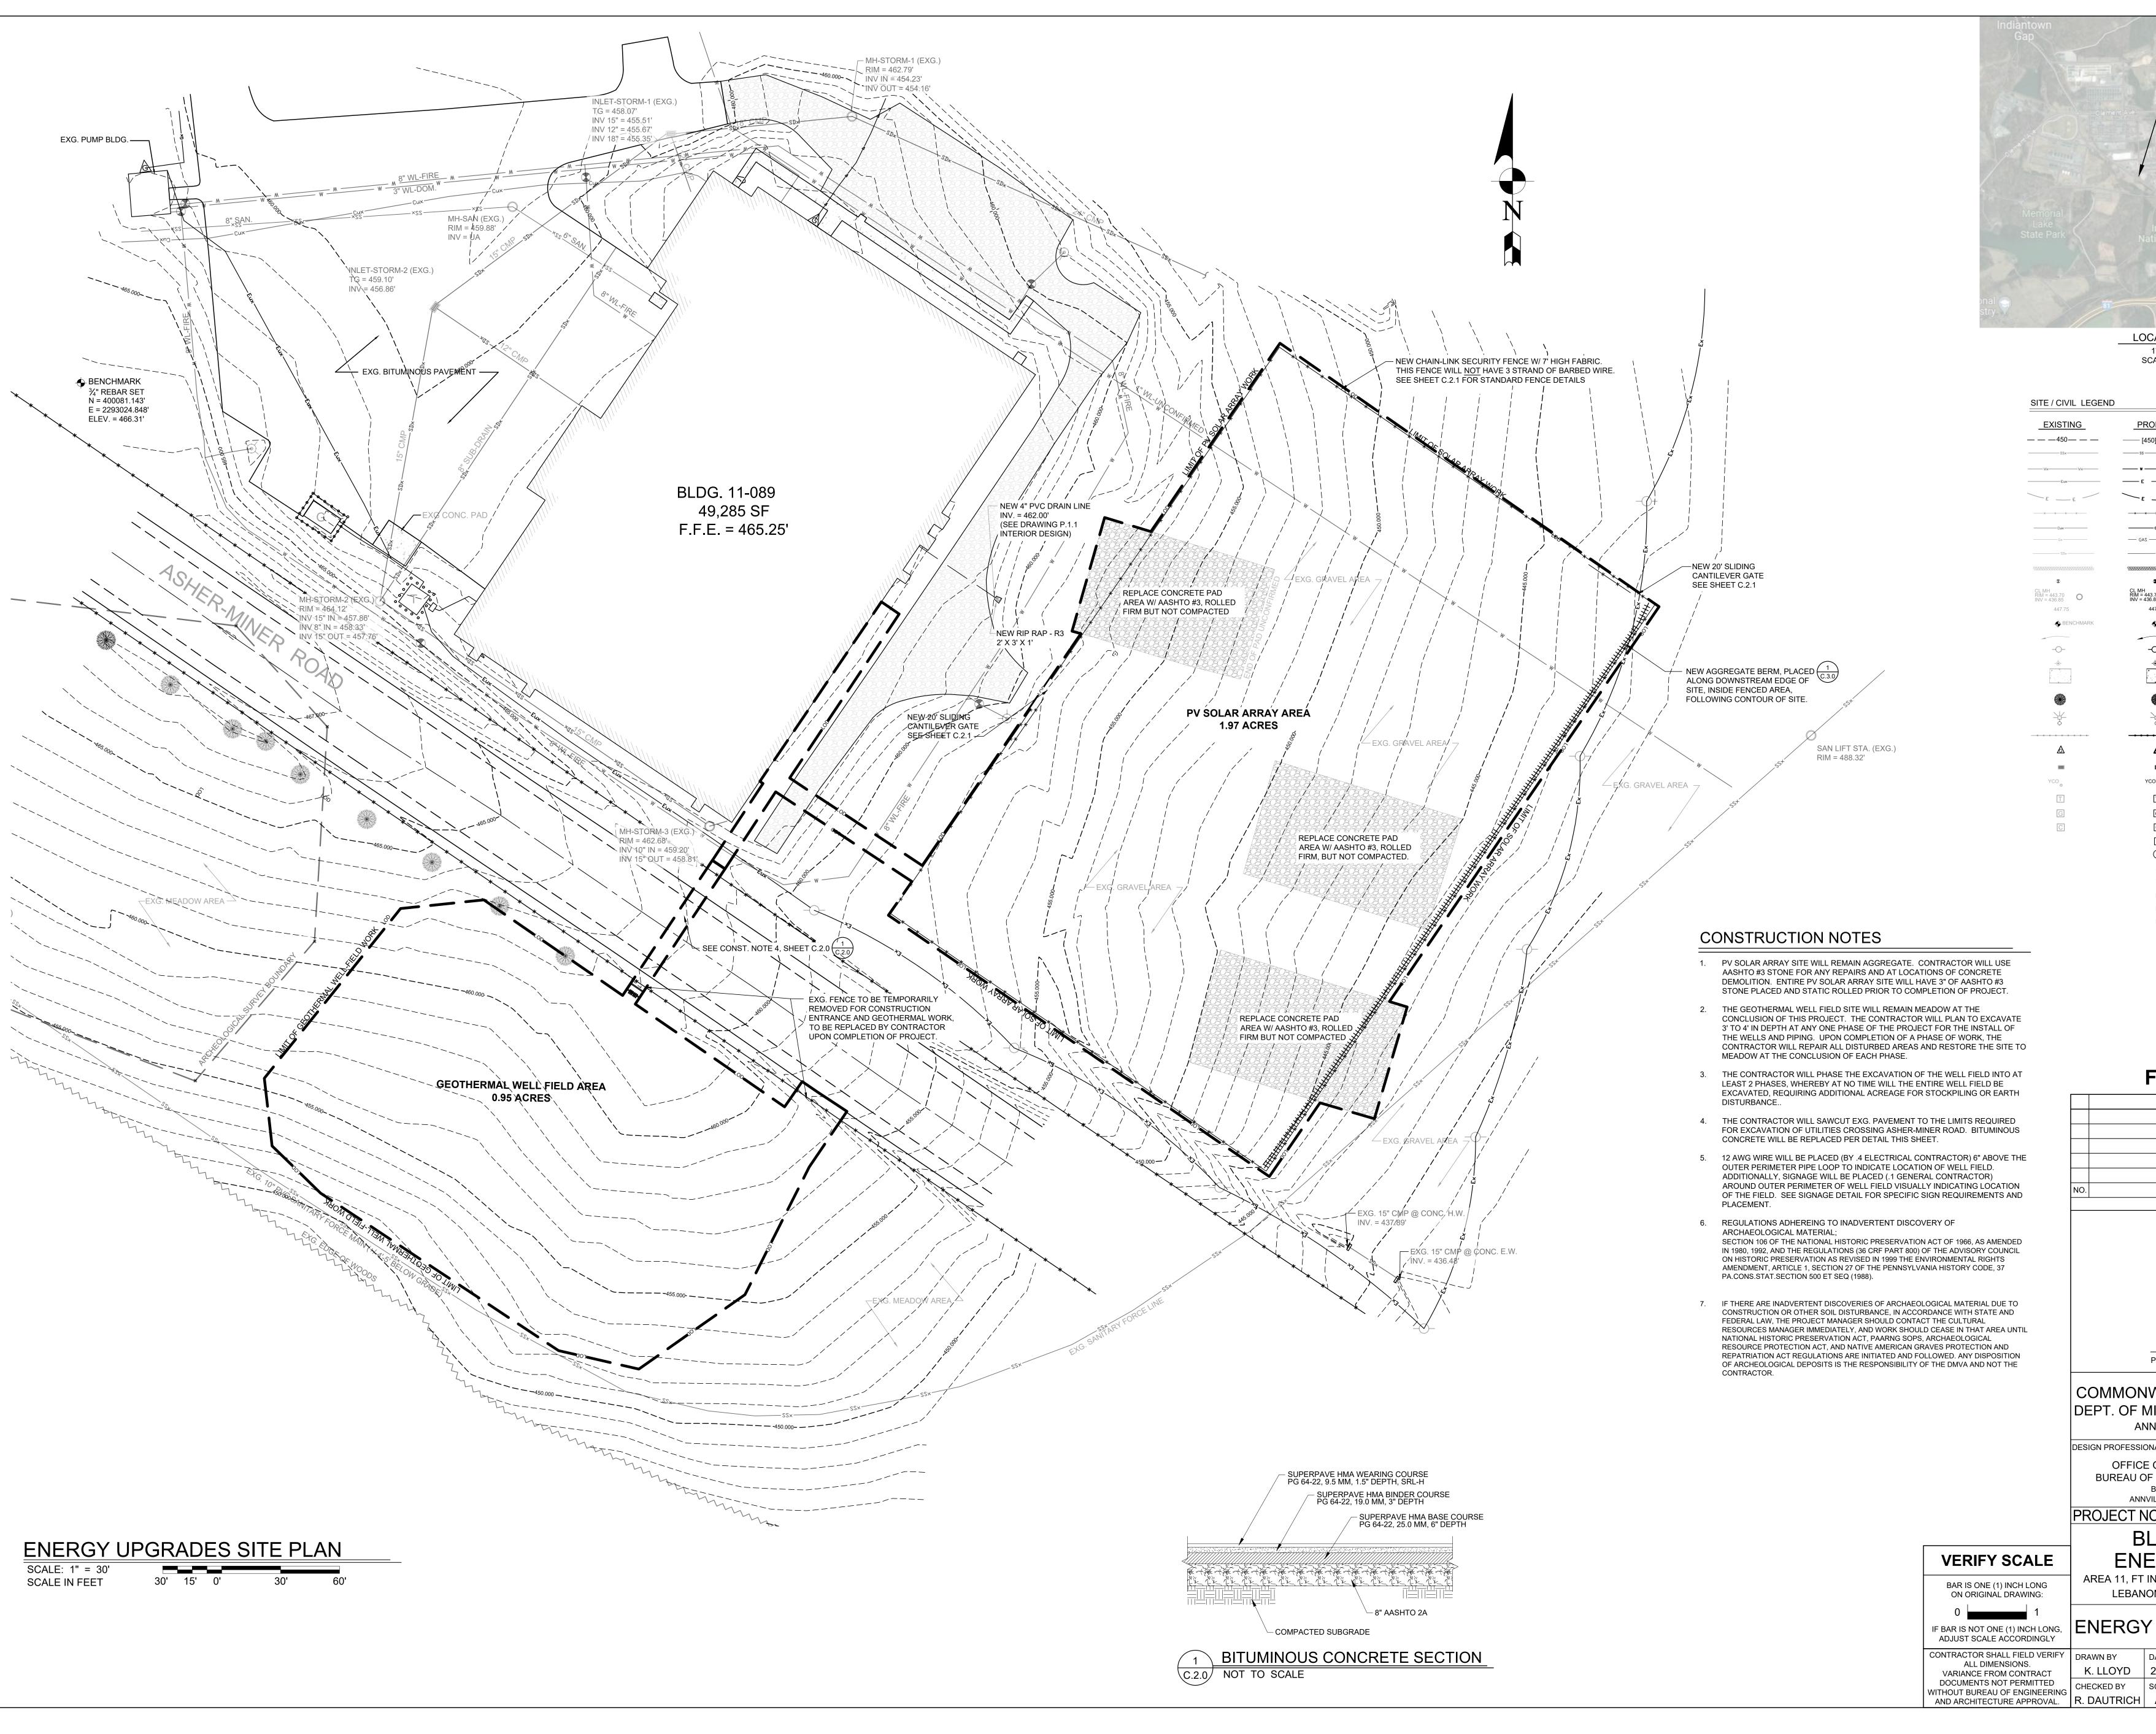

	A STANT STA	
		1
	Fort Indiantown G	ap
PROJE	CT SITE	\mathbf{x}^{O}
		80 G
		1
Indiantown G tional Cemet		
		1
		121
CATION MAR		-
1" = 2,000' CALE IN FEET		
OPOSED		
	CONTOUR LINE SANITARY SEWER	
	WATER LINE ELECTRIC - UNDERGROUND	
E	ELECTRIC - OVERHEAD	
— X X X	FENCELINE COMMUNICATION - UNDERGROUND	
013	NATURAL GAS STORM SEWER	
	EROSION FILTER SOCK	
13.70 O 6.85 O	MANHOLE	
447.75	SPOT ELEVATION BENCHMARK ELEVATION	
- O -	FLOW ARROW UTILITY POLE	
	FIRE HAYDRANT CONCRETE HATCH	
	TREE	
- - -	POLE MOUNTED AREA LIGHTING	
 	PENNDOT STANDARD GUIDE RAIL	
	STORM INLET	
со <mark>,</mark> Т	SANITARY YARD CLEAN OUT ELECTRICAL TRANSFORMER W/ VAULT	
C	COMMUNICATIONS MANHOLE ELECTRIC PULL-BOX	
O A1	BOLLARD GEOTHERMAL WELL IDENTIFICATION	
TW MWO-1	GEOTHERMAL TEST WELL MONITORING WELL OUTER LOOP	
MWM-1 MWI-1	MONITORING WELL MIDDLE LOOP	
FINAL	DESIGN	
DES	CRIPTION	DATE
RE	/ISIONS	
Professional's Si	gnature Date	
	OF PENNSYL	/ΔΝΙΔ
	& VETERAN'S AF	
	NNSYLVANIA 17003	
NALS:	IES AND ENGINEERING	
F DESIGN AN	ND PROJECT MANAGEM	
	420591 (888	321)
	1-89 TISA	(ו בי
	UPGRADES	
NDINATOWI	N GAP, EAST HANOVER	R TWP.
ON COUNTY	, PENNSYLVANIA 1700	3
UPGF	RADES SITE F	PLAN
DATE	DRAWING NO.	
29 APR 2024 SCALE	4 C.2.0	

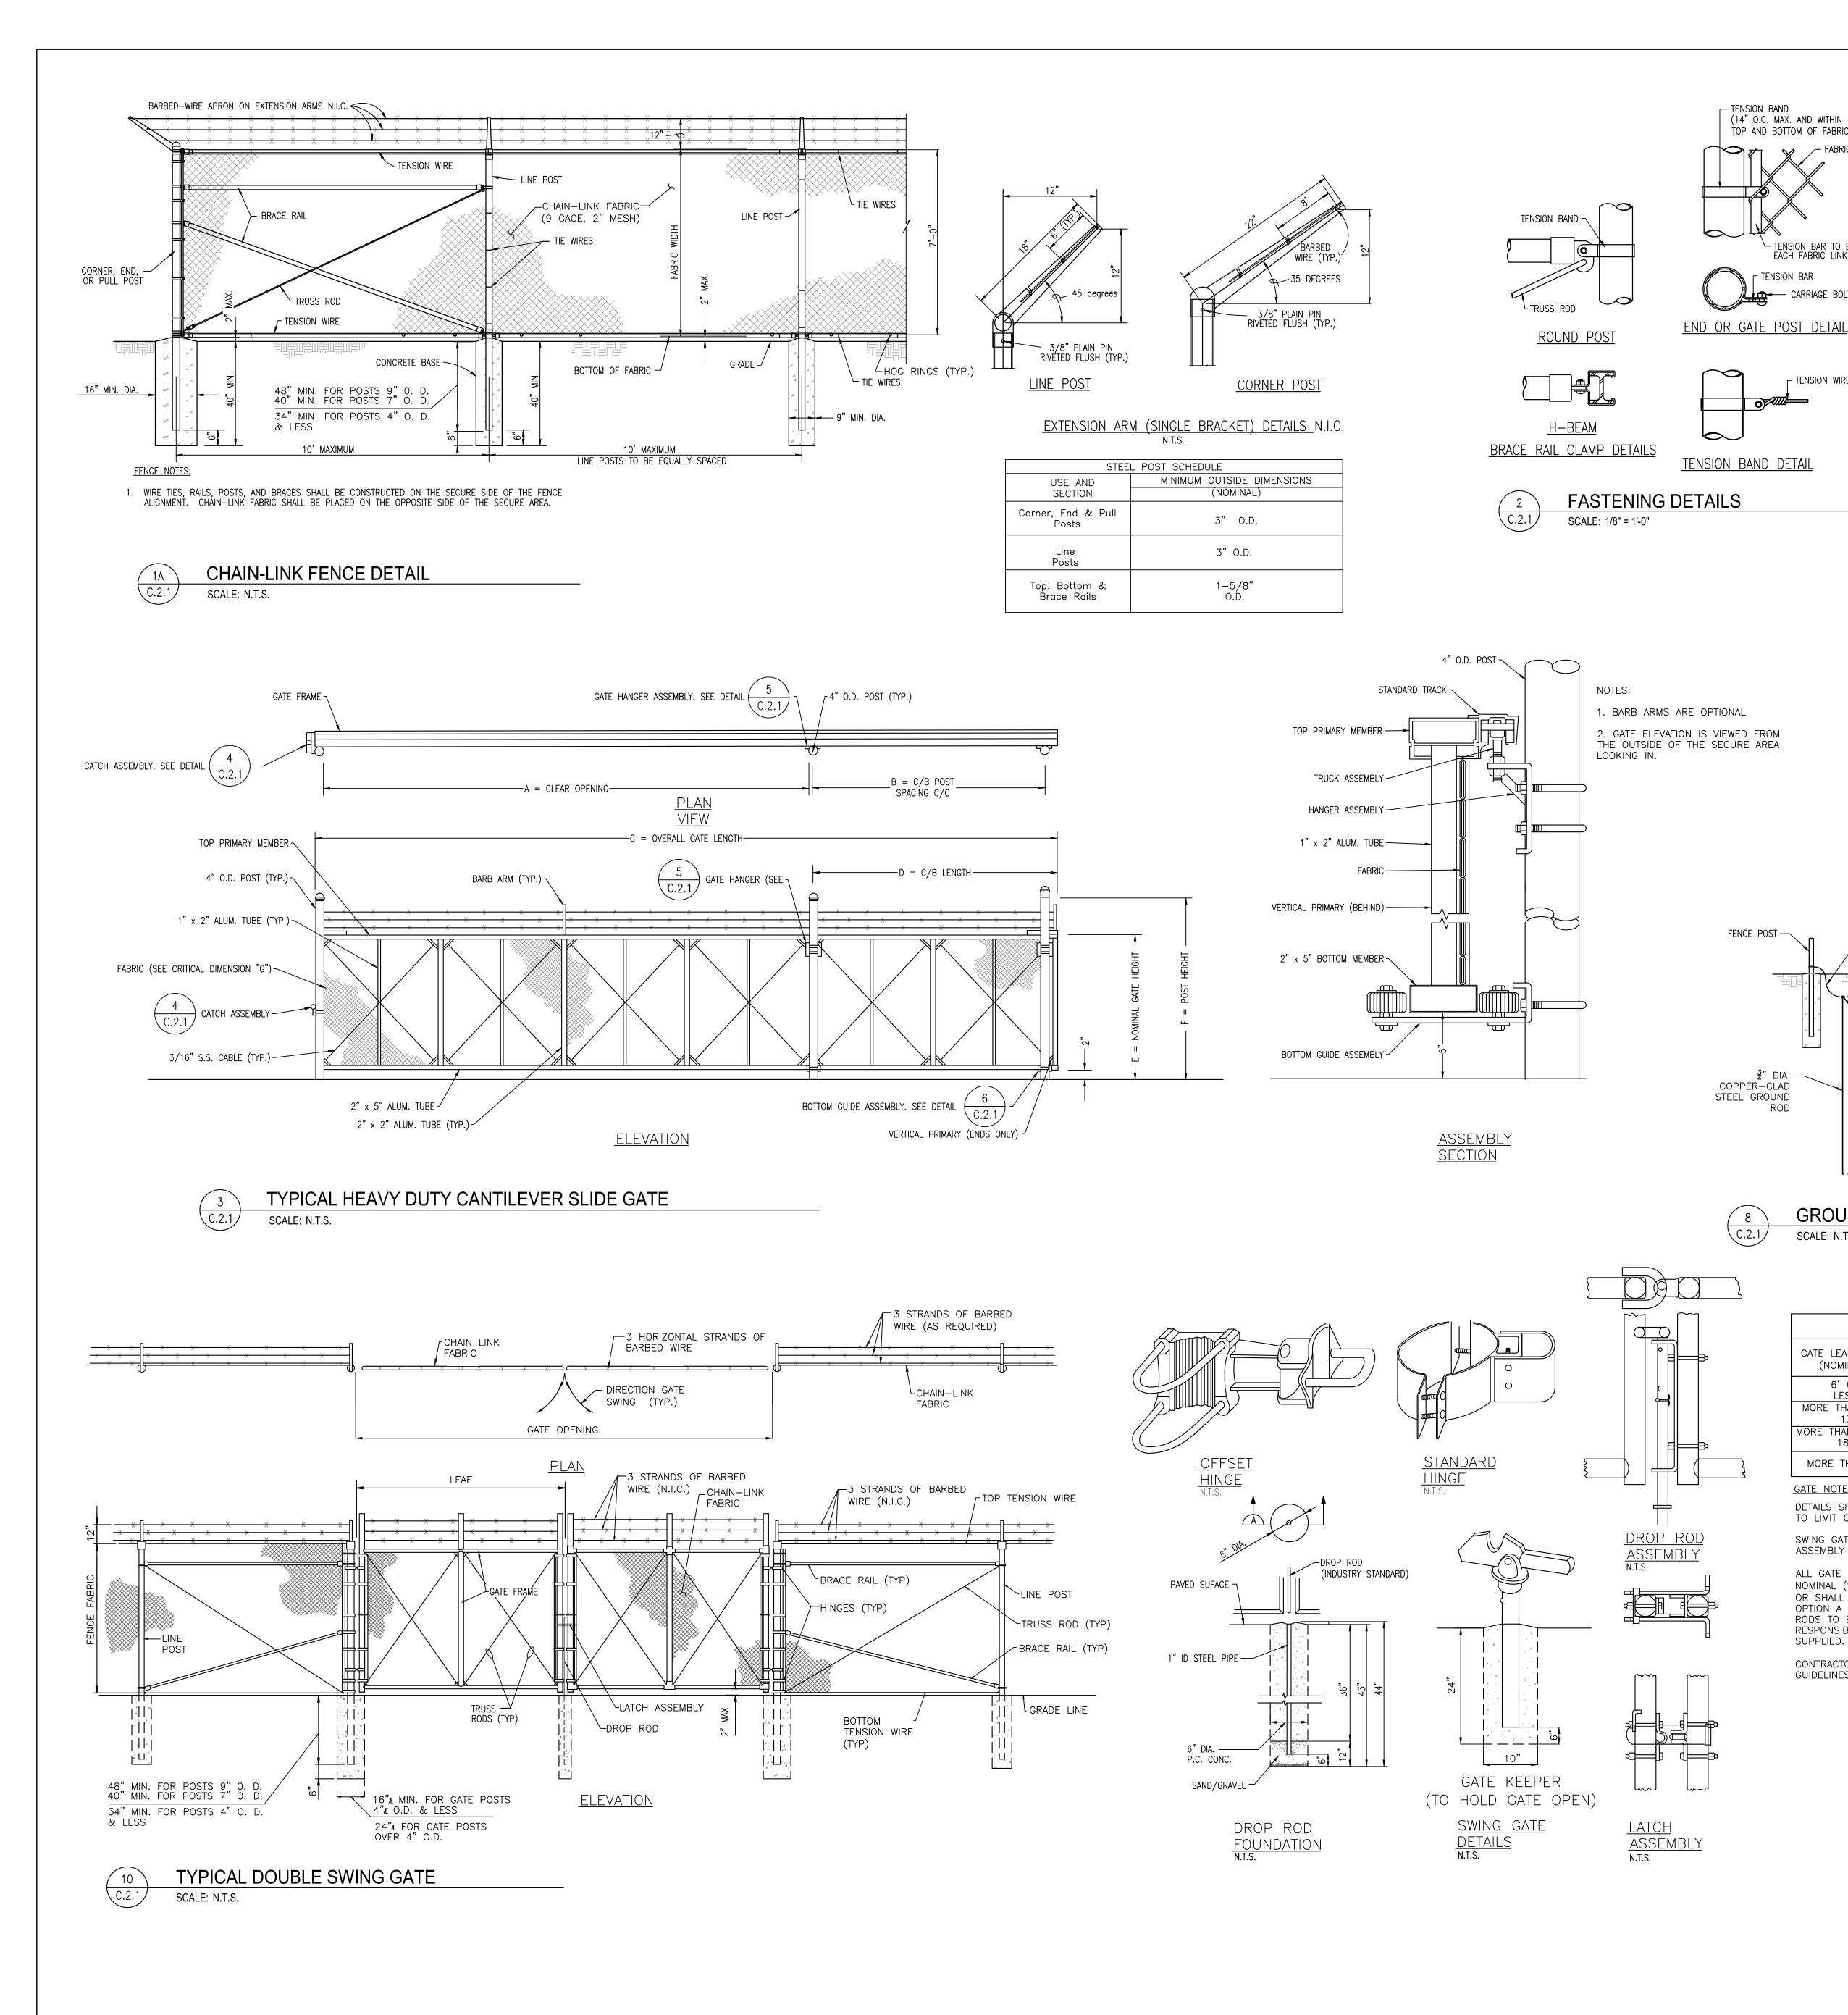

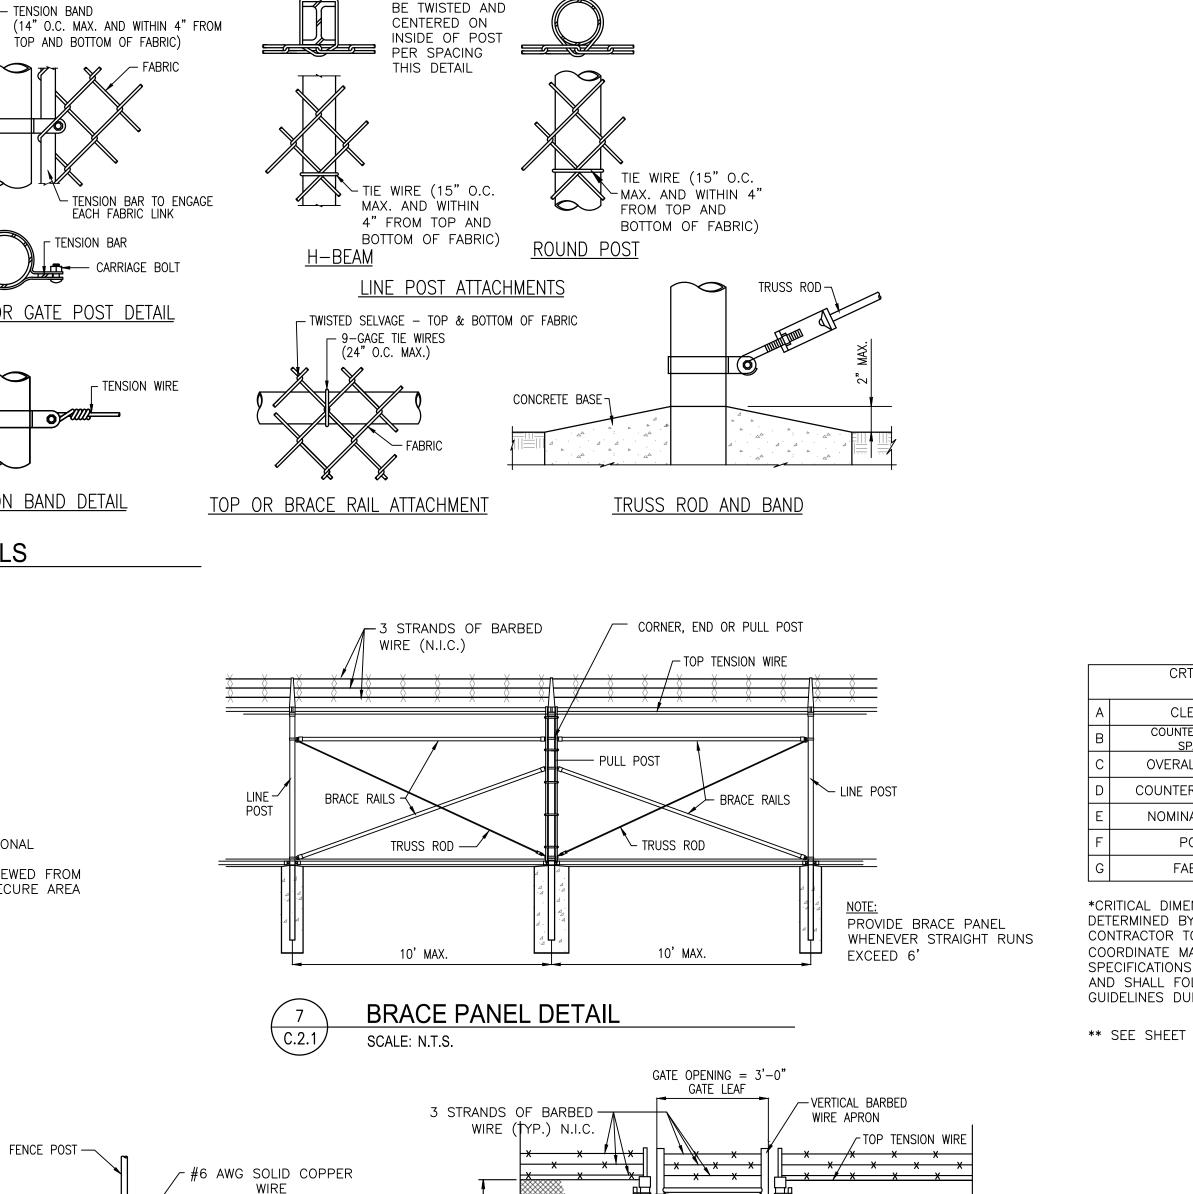

🕅 HINGE —

HINGE

SCALE: N.T.S.

à à

PERSONNEL GATE

VTRUSS

ROD

· ⊿

GATE POST-

、C.2.1/

-BRACE RAIL

BRACE RAIL

-TRUSS ROD

WIRE - CHAIN-LINK

FABRIC

GRADE LINE

- BOTTOM TENSION

BAR IS ONE (1) INCH LONG

ON ORIGINAL DRAWING:

)

ALL DIMENSIONS.

-LATCH

Y TIE WIRE WILL-

GATE POST SCHEDULE									
GATE LEAF WIDTH (NOMINAL)	OUTSIDE DIMENSION (NOMINAL)								
6'OR LESS	3" O.D.								
MORE THAN 6' TO 13'	4" O.D.								
MORE THAN 13" TO 18"	7" O.D.								
MORE THAN 18'	9"O.D.								

MOLDED EXOTHERMIC WELD OR APPROVED CLAMPED-TYPE FITTING OF

COPPER

GROUNDING DETAIL

<u>GATE NOTES:</u>


SUPPLIED.

SCALE: N.T.S.


DETAILS SHOWN ARE TO CLARIFY REQUIREMENTS AND ARE NOT INTENDED TO LIMIT OTHER TYPE OF FENCE SECTIONS AND METHODS OF INSTALLATION. SWING GATES SHALL BE CONSTRUCTED WITH DROP RODS, PADLOCKS, LATCH ASSEMBLY AND GATE KEEPERS EXCEPT AS NOTED.

ALL GATE FRAMES SHALL BE A MINIMUM 2" NOMINAL (ROUND) OR 2" NOMINAL (SQUARE). GATE FRAMES SHALL BE OF WELDED CONSTRUCTION OR SHALL BE ASSEMBLED USING HEAVY FITTINGS. AT CONTRACTOR'S OPTION A WELDED HORIZONTAL BRACE MAY BE USED IN LIEU OF TRUSS RODS TO BRACE ALL WELDED GATE FRAMES. THE CONTRACTOR SHALL BE RESPONSIBLE FOR THE PROPER RIGID CONSTRUCTION OF ALL GATES

CONTRACTOR SHALL FOLLOW MANUFACTURER'S SPECIFICATIONS AND GUIDELINES FOR INSTALLATION.

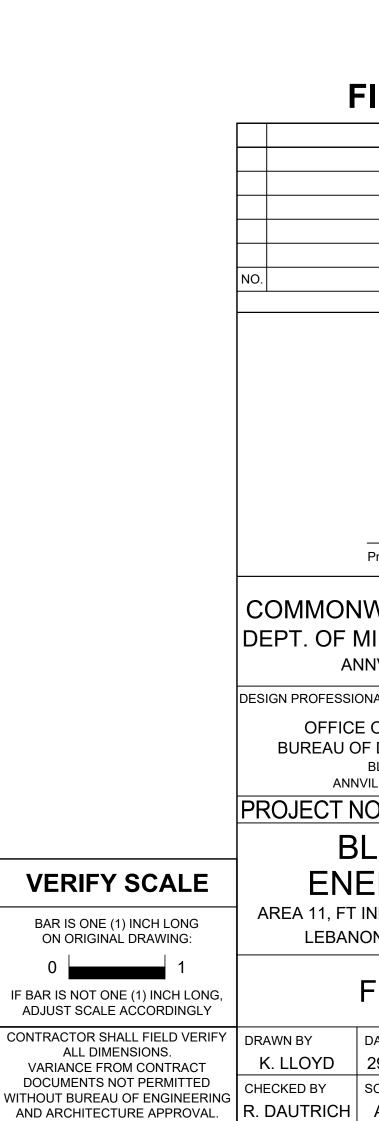

CRTICAL DIMENSION CHART	
CLEAR OPENING**COUNTERBALANCE POST*SPACING C/C*OVERALL GATE LENGTH*	
UNTERBALANCE LENGTH * IOMINAL GATE HEIGHT 7' POST HEIGHT * FABRIC HEIGHT *	
DIMENSIONS TO BE ED BY MANUFACTURER. OR TO VERIFY AND TE MANUFACTURER'S TIONS PRIOR TO PURCHASE LL FOLLOW MANUFACTURER TS DURING INSTALLATION.	
HEET C.1.0 FOR CLEAR OPENING DIMENSION	IS
FINAL DESIGN	
FINAL DESIGN	
FINAL DESIGN	
DESCRIPTION REVISIONS	DATE
DESCRIPTION	DATE
DESCRIPTION	DATE
DESCRIPTION	DATE
	/ANIA
DESCRIPTION REVISIONS Professional's Signature Date DATE DATE DATE DATE DATE DATE DATE DATE	/ANIA FAIRS
DESCRIPTION REVISIONS Professional's Signature Date DNVVEALTH OF PENNSYLV F MILITARY & VETERAN'S AF ANNVILLE, PENNSYLVANIA 17003 SSIONALS: ICE OF FACILITIES AND ENGINEERING J OF DESIGN AND PROJECT MANAGEM BLDG. 0-10, FORT INDIANTOWN GAP ANNVILLE, LEBANON COUNTY, PENNSYLVANIA NO.: 420591 (888 BLDG. 11-89 TISA NERGY UPGRADES FT INDINATOWN GAP, EAST HANOVER	/ANIA FAIRS ENT 321) R TWP.
DESCRIPTION REVISIONS Professional's Signature Date DNVVEALTH OF PENNSYLV F MILITARY & VETERAN'S AF ANNVILLE, PENNSYLVANIA 17003 SSIONALS: ICE OF FACILITIES AND ENGINEERING J OF DESIGN AND PROJECT MANAGEM BLDG. 0-10, FORT INDIANTOWN GAP ANNVILLE, LEBANON COUNTY, PENNSYLVANIA NO.: 420591 (888 BLDG. 11-89 TISA NERGY UPGRADES	/ANIA FAIRS ENT 321) R TWP.

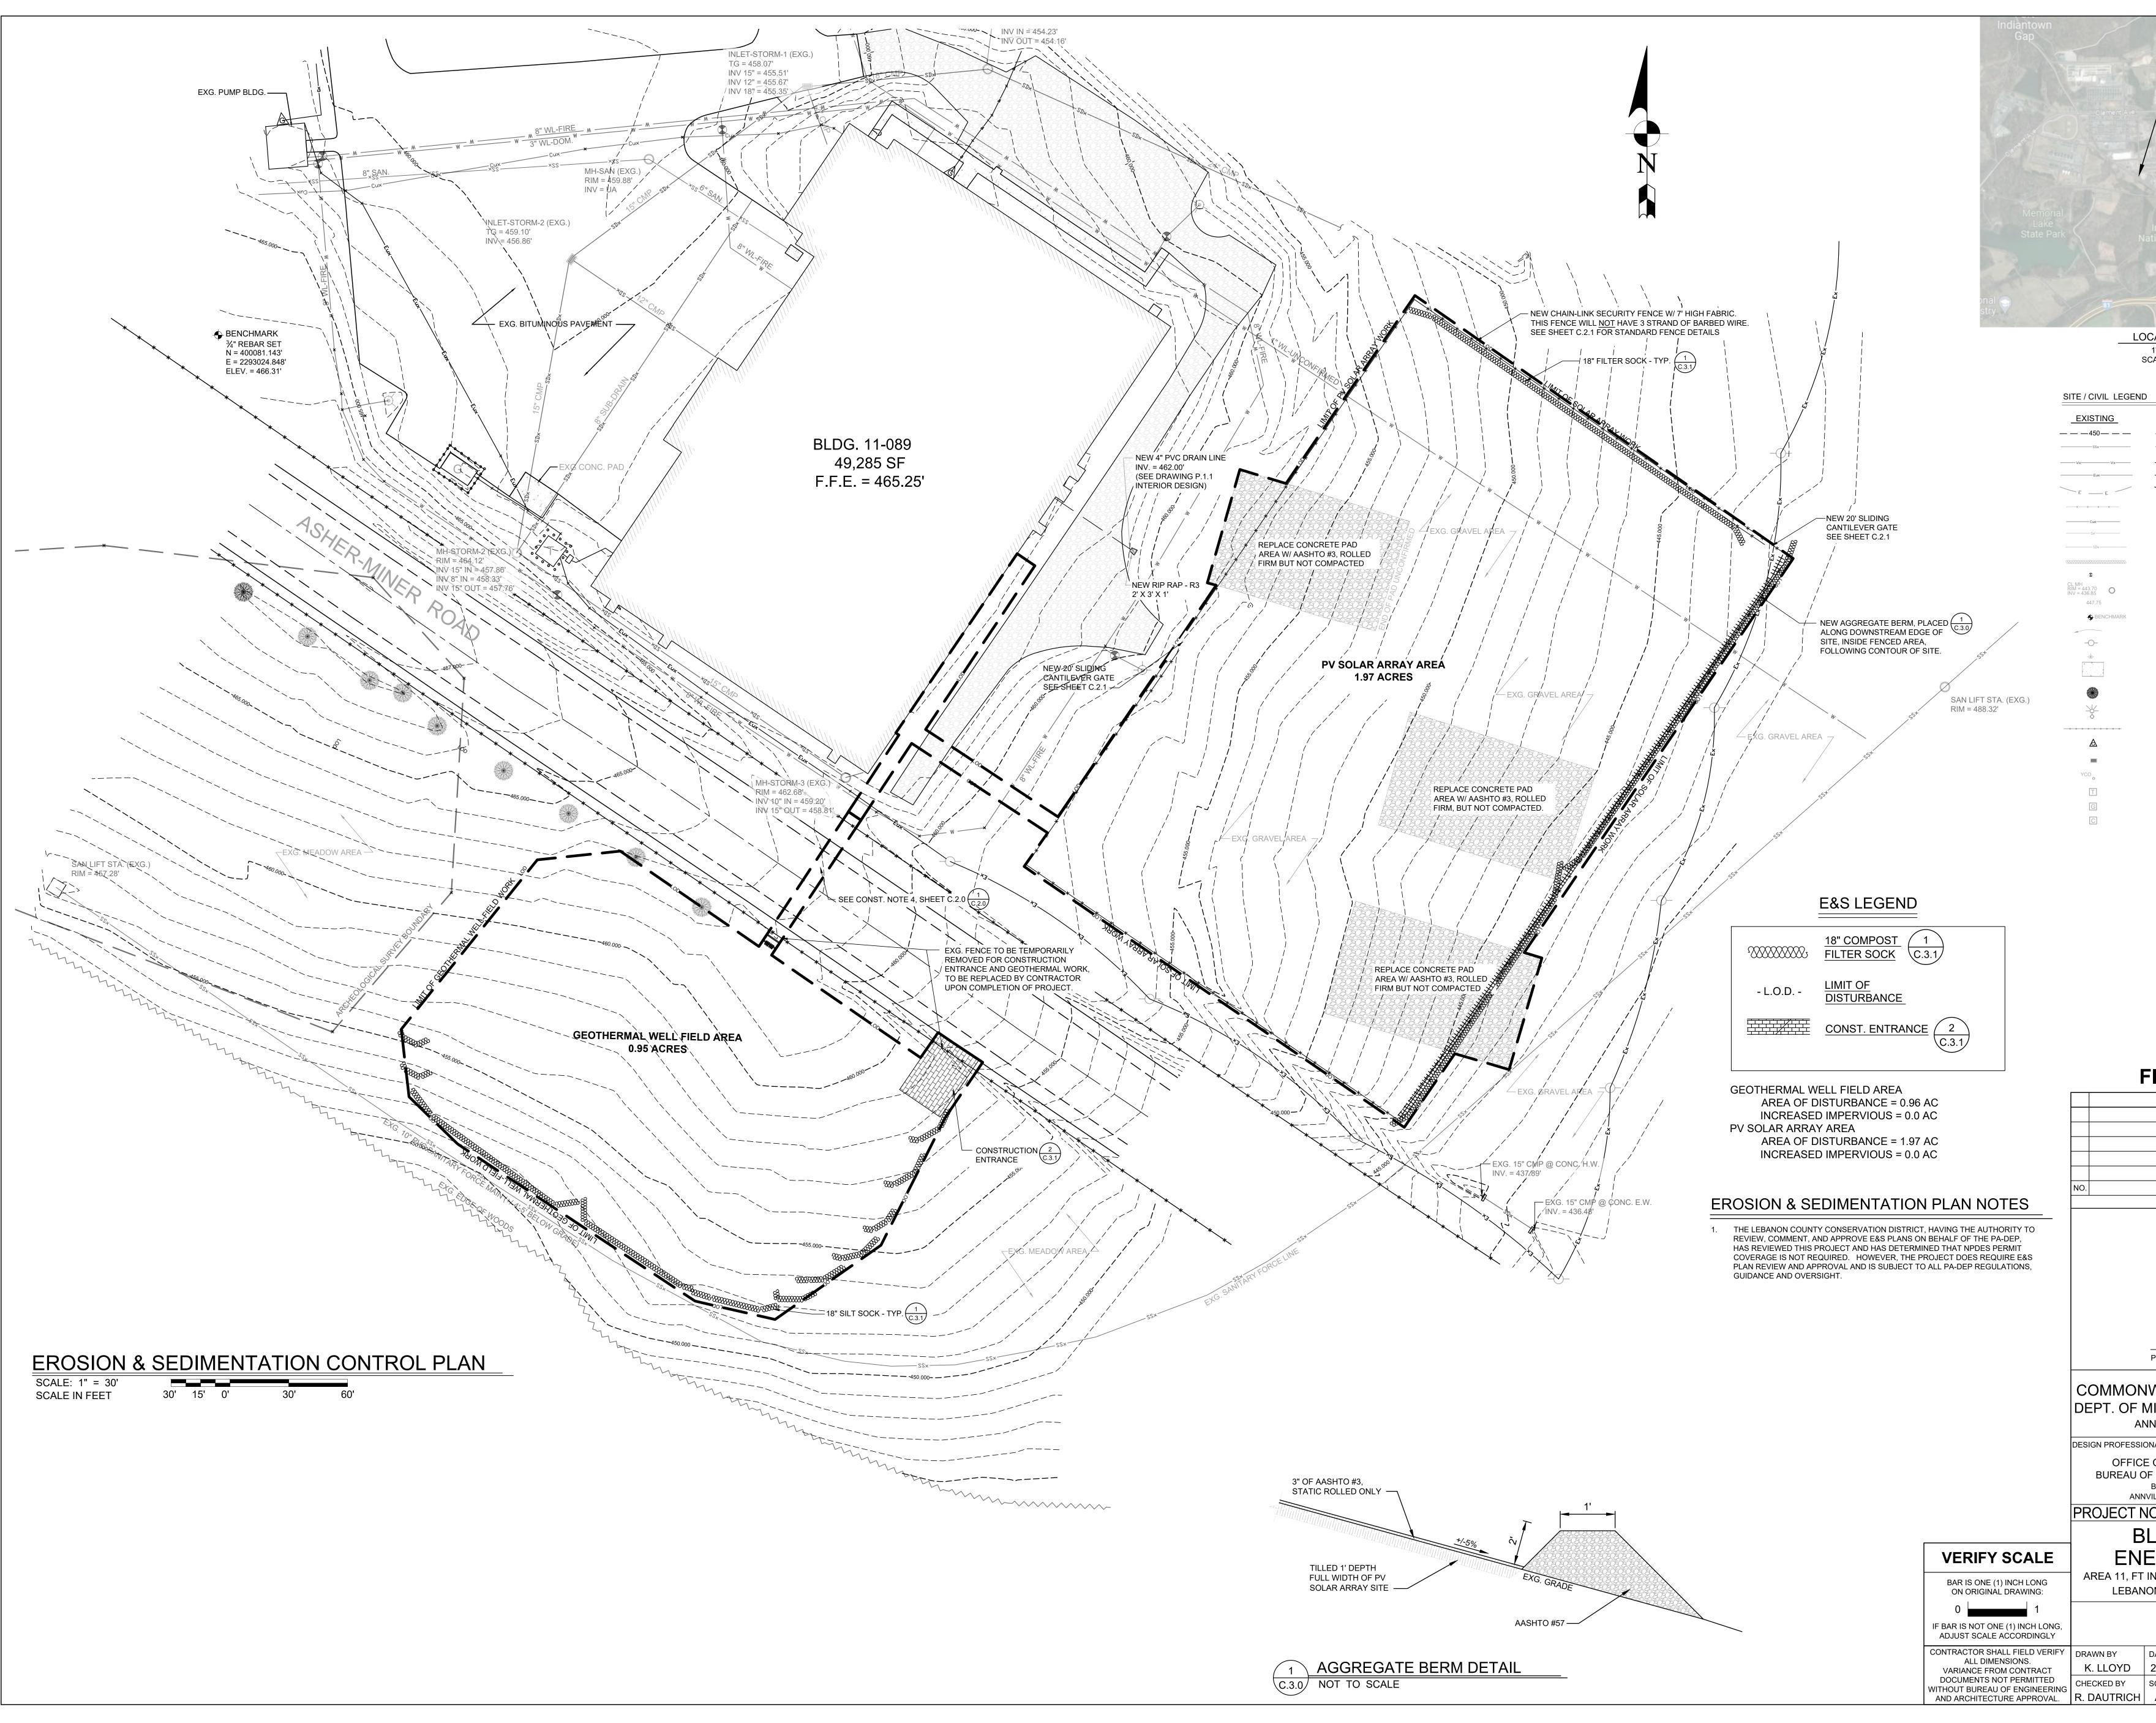

- Part .		
E. Cont	Fort Indiantown G	ар
	9	0
PROJECT SI		
Indiantown Gap		-
CATION MAP		
1" = 2,000' CALE IN FEET		
PROPOSED		
[450]	CONTOUR LINE SANITARY SEWER	
—— w —— w ——	WATER LINE ELECTRIC - UNDERGROUND	
	ELECTRIC - OVERHEAD	
<u> </u>	FENCELINE COMMUNICATION - UNDERGROU	JND
GAS GAS SD	NATURAL GAS STORM SEWER	
•••••••••••••••••••••••••••••••••••••••	EROSION FILTER SOCK	
CL MH RIM = 443.70 INV = 436.85 447.75	MANHOLE SPOT ELEVATION	
G BENCHMARK	BENCHMARK ELEVATION	
-0-	UTILITY POLE	
	CONCRETE HATCH	
*	TREE POLE MOUNTED AREA LIGHTING	
- -	PENNDOT STANDARD GUIDE RA	
	NATURAL GAS VALVE/METER	
YCO [°]	SANITARY YARD CLEAN OUT	
T G	ELECTRICAL TRANSFORMER W/	VAULT
C	COMMUNICATIONS MANHOLE	
O A1	BOLLARD GEOTHERMAL WELL IDENTIFICA	TION
TW MWO-1	GEOTHERMAL TEST WELL	
MWW-1 MWI-1	MONITORING WELL MIDDLE LOO	P
INAL DE	SIGN	
DESCRIPTION REVISION		DATE
		DATE
REVISIO	NS	DATE
REVISION Professional's Signature WEALTH OF IILITARY & VI NVILLE, PENNSY NALS:	Date Date F PENNSYLV ETERAN'S AF	/ANIA FAIRS
REVISION Professional's Signature WEALTH OF IILITARY & VI NVILLE, PENNSY NALS: OF FACILITIES A DESIGN AND PR BLDG. 0-10, FORT IND ILLE, LEBANON COUN	Date Date Date FPENNSYLV ETERAN'S AF LVANIA 17003 ND ENGINEERING OJECT MANAGEM ANTOWN GAP TY, PENNSYLVANIA	/ANIA FAIRS
REVISION Professional's Signature WEALTH OF IILITARY & VI NVILLE, PENNSY NALS: OF FACILITIES A DESIGN AND PR BLDG. 0-10, FORT INDI ILLE, LEBANON COUNT O.: DG. 11-8 RGY UP NDINATOWN GAF	Date Date Date Date PENNSYLV ETERAN'S AF LVANIA 17003 ND ENGINEERING OJECT MANAGEM ANTOWN GAP TY, PENNSYLVANIA 420591 (888 39 TISA GRADES P, EAST HANOVEF	ANIA FAIRS ENT 321)
REVISION Professional's Signature WEALTH OF IILITARY & VI NVILLE, PENNSY NALS: OF FACILITIES A DESIGN AND PR BLDG. 0-10, FORT INDI ILLE, LEBANON COUNT O.: DG. 11-8 RGY UP NDINATOWN GAF	Date Date Date PENNSYLV ETERAN'S AF LVANIA 17003 ND ENGINEERING OJECT MANAGEM ANTOWN GAP TY, PENNSYLVANIA 420591 (888 39 TISA GRADES P, EAST HANOVEF NSYLVANIA 17003	ANIA FAIRS ENT 321)
Professional's Signature WEALTH OF IILITARY & VI NVILLE, PENNSY NALS: OF FACILITIES A DESIGN AND PR BLDG. 0-10, FORT INDI IILLE, LEBANON COUNT O.: DG. 11-8 ERGY UP NDINATOWN GAF DN COUNTY, PEN	Date Date Date PENNSYLV ETERAN'S AF LVANIA 17003 ND ENGINEERING OJECT MANAGEM ANTOWN GAP TY, PENNSYLVANIA 420591 (888 39 TISA GRADES P, EAST HANOVEF NSYLVANIA 17003	ANIA FAIRS ENT 321)

EROSION & SEDIMENTATION CONTROL NOTES

1-0 GENERAL NOTES

- 1. At least 10 days before starting any earth disturbance activities, the contractor shall invite all DMVA POC's and maintenance personnel involved in those activities, the landowner, all appropriate municipal officials, the erosion and sedimentation control plan preparer, and a representative of the Lebanon County Conservation District at 717-277-5275 to schedule an on-site pre-construction meeting. Also, at least 3 days before starting any earth disturbance activities, the contractor shall notify the Pennsylvania One Call System Inc. at 1-800-242-1776 for buried utilities location.
- 2. Before implementing any revisions to the approved erosion and sediment control plan or revisions to other plans which may affect the effectiveness of the approved E&S control plan, the contractor receive written approval of the revisions from the Lebanon Conservation District.
- 3. The contractor shall remove from the site, recycle or dispose of all waste materials (tree stumps, brush etc.) in accordance with the Department's Solid Waste Management Regulations at 25 PA Code 260.1 et seq., 271.1 e. seq. and 287.1 et seq.
- 4. Before disposing of soil or receiving borrow for the site, the contractor must assure that each spoil or borrow area has an erosion and sediment control plan approved by the Lebanon Conservation District, and which is being implemented and maintained according to Chapter 102 regulations. The contractor shall also notify the Lebanon Conservation District in writing of all receiving spoil and borrow areas when they have been identified.
- 5. Only limited disturbance will be permitted to provide access to construct construction BMPs.
- 6. Erosion and sedimentation controls must be constructed, stabilized, and functional before site disturbance within the tributary areas of those controls.
- 7. After final site stabilization has been achieved, temporary erosion and sedimentation controls must be removed. Areas disturbed during removal of the controls must be stabilized immediately.
- 8. At the end of each working day, any sediment tracked or conveyed onto a public roadway will be removed and redeposited onto the construction site. Removal can be completed through use of mechanical or hand tools, but must never be washed off the road by use of water.
- Sediment removed from E&SPC controls & facilities shall be disposed of in landscaped areas outside of steep slopes wetlands, floodplains or drainage swales and immediately stabilized, or placed in topsoil stockpiles.
- 10. All pumping of sediment laden water shall be through a dirt bag filtration device, or equivalent sediment removal facility, over non-disturbed vegetated areas. Discharge points should be established to provide for maximum distance to active waterways.
- 11. Should unforeseen erosive conditions develop during construction, the contractor shall take immediate action to remedy such conditions and to prevent damage to adjacent properties as a result of increased runoff and/or sediment displacement. Stockpiles of wood chips, hay bales, crushed stone and other mulches shall be held in readiness to deal immediately with emergency problems of erosion.
- 12. The contractor is advised to become thoroughly familiar with the provisions of the Appendix 64, Erosion Control Rules and Regulations, Title 25, Part 1, Department of environmental Protection, Subpart C, Protection of Natural Resources, Article III, Water Resources, Chapter 102, Erosion Control.
- 13. A copy of this erosion and sedimentation control report and plans must be posted at the construction site.
- 14. Failure to correctly install sediment control facilities **or** failure to prevent sediment laden runoff from leaving the construction site or failure to take corrective actions to immediately resolve failures of sediment control facilities may result in administrative, civil and/or criminal penalties being instituted by the Pennsylvania Department of Environmental Protection as defined in Section 602 of the Clean Streams Law of Pennsylvania. The Clean Streams Law provides for up to \$10,000 per day in civil penalties, up to \$10,000 in summary criminal penalties, and up to \$25,000 in misdemeanor criminal penalties for each violation.

2-0 STABILIZATION NOTES

- 1. Stockpile heights must not exceed 35'. Stockpile slopes must be 2:1 or flatter.
- 2. Upon completion of an earth disturbance activity or any stage or phase of an activity, the contractor shall stabilize immediately the disturbed areas to protect from accelerated erosion. During non-germinating periods, mulch must be applied at the specified rates. Disturbed areas which are not at finished grade and which will be redisturbed within 1 year may be stabilized in accordance with temporary seeding specifications. Disturbed areas, which are either at finished grade or will not be redisturbed within 1 year, must be stabilized in accordance with permanent seeding specifications.
- 3. Stockpiles must be stabilized immediately.
- 4. Hay or straw mulch must be applied at rates of at least 3.0 tons per acre.
- 5. Until the site has achieved final stabilization the contractor shall properly implement, operate and maintain all the best management practices. Maintenance shall include inspections of all erosion and sedimentation control after each runoff event and on a weekly basis. All preventative and remedial maintenance work, including clean out, repair, replacement, regrading, reseeding, remulching, and renetting, must be performed immediately.

- 6. An area shall be considered to have achieved final stabilization when it has a minimum uniform 70% perennial vegetative cover or other permanent non-vegetative cover with a density sufficient to resist accelerated surface erosion and subsurface characteristics sufficient to resist sliding or other movements.
- 7. Mulch with mulch control netting or erosion control blankets must be installed on all slopes greater than 3:1.

2-1 COMPOST FILTER SOCK

- 1. Compost sock should be placed parallel to contours with both ends of the sock extended upslope at a 45 degree angle to the rest of the sock to prevent end-arounds.
- 2. Socks placed on earthen slopes should be anchored with stakes driven through the center of the sock or immediately down slope of the sock as per detail.
- 3. Any section of compost sock, which has been undermined or topped, must be immediately replaced.

3-0 CONSTRUCTION SEQUENCE NOTES

1. All earth disturbance activities shall proceed in accordance with the following sequence. Each stage shall be completed in compliance with Chapter 102 regulations before any following stage is initiated. Clearing and grubbing shall be limited only to those areas described in each stage.

2. Flag the limit of disturbance.

- 3. Install compost filter sock as per plan.
- 4. Install Construction Entrance.
- 5. Mobilize construction equipment.
- 6. Till PV Solar Array Site and install Aggregate Berm.
- 7. Complete Solar Array and Geothermal Well Installation.
- 8. Repair any disturbed areas.
- 9. Place 3" of AASHTO #3 over entire PV Solar Array site.
- 10. Overseed Geothermal Well Field Area.
- 11. After site is stabilized, remove temporary BMP's and stabilize.

4.0 GROUND COVER

4.1 Temporary Seeding

- 1. All grass areas disturbed by the work of this Project shall be seeded as follows:
- 2. Temporary seeding shall be done in areas where active work will not be performed for twenty days (20). Temporary seeding shall be done immediately after work ceases.
- 3. Apply agricultural lime and fertilizer as follows for temporary seeding:

3.1. Agricultural Lime -- 50 pounds per 1,000 square feet -- 12 pounds per 1,000 square feet 3.2. Fertilizer

- 4. Fertilizer shall be a commercial type 10-20-20.
- 5. Temporary seed mixture Annual Ryegrass -- 1 pound per 1,000 square feet.
- 6. All temporary seeding shall be mulched. Temporary seeding shall be watered as required to develop cover.
- 7. Mulch shall be straw, shall be clean and free from noxious weeds, and shall be applied at the rate of 140 pounds per 1,000 square

4.2 Permanent Seeding

- 1. Permanent seeding shall take place in all disturbed areas as follows
- 2. Fertilization: The following shall be spread and worked into the topsoil to a depth of 3 to 4 inches.
- 2.1. Agricultural Lime 275 pounds per 1,000 square feet 2.2. Fertilizer 25 pounds per 1,000 square feet
- 3. The fertilizer shall be a commercial type 10-20-20.
- 4. Note: If agricultural lime and fertilizer have been applied previously to the ground where the permanent seed is to be applied, the lime and fertilizer rates shall be reduced by the amount by what has been applied previously.
- 5. **Permanent Seed Mixture:** The following seed mixtures shall be applied as follows:
- 6. FTIG ITAM Mix (requires proper legume inoculants)
- 6.1. 10% Annual Ryegrass
- 6.2. 25% Perennial Regrass 6.3. 20% Medium Ryegrass
- 6.4. 10% White Ladino Clover
- 6.5. 10% White Dutch Clover 6.6. 10% Vernal Alfalfa 6.7. 10% Norcen Birdsfoot Trefoil
- 6.8. 5% Crimson
- 7. **PENNDOT Formula L Low Grow Mix**

7.1. 35% Creeping Red Fescue 7.2. 27.5% Defiant Hard Fescue

- 7.3. 27.5% Stonehenge Fescue 7.4. 10% Annual Ryegrass
- 8. FTIG Legume Mix(plant with Low Grow at rate 10#/acre, requires inoculant)
- 8.1. 20% White Ladino Clover
- 8.2. 10% Medium Red Clover 8.3. 10% Mammoth Red Clover
- 8.4. 10% White Dutch Clover
- 8.5. 10% Alsike Clover 8.6. 20% Vernal Alfalfa
- 8.7. 10% Norcen Birdsfoot Trefoil 8.8. 10% Crimson Clover

8.9. *All mixtures given above are for PLS - Pure Live Seed 100%. To calculate PLS, the percentage of pure seed is multiplied by the percentage of germination, and the product is divided by 100. (85% pure seed x 72% germination) divided by 100 = 61% PLS. To determine how much seed to plant, divide the percentage into 100. Example: 100 divided by 61 = 1.63. Thus, every pound of seed mixture called for should then be 1.63 lbs.

square feet.

land.

2. Mulched areas shall be checked weekly and immediately after severe storms for damage, until the mulching is no longer necessary for protection against erosion. Damaged portions of the mulch or tie down materials shall be repaired as soon as discovered

5.2 Periodic Inspection Program

regrading, reseeding, remulching, and renetting must be

required.

- been stabilized.

8.8. 10% Crimson Clover

9. Mulch: Apply mulch to all permanently seeded areas.

9.1. Materials: Straw, air-dried and free from undesirable seeds and course materials. Application: 140 pounds per 1,000

5.0 MAINTENANCE PROGRAM

5.1 Emergency Erosion Protection

1. If erosion does occur, the contractor shall repair and reseed those areas or use other stabilization methods as required. The contractor shall use jute, wood fiber, or other tie down filter netting on top of the new seed as required, regardless of the slope of the


1. The contractor will regularly inspect the Project's erosion and sedimentation controls during the entire active construction stages. The inspections will be performed weekly or after all runoff events and the inspections shall be documented and records of repairs keep on site. The contractor will be responsible for the installation, operation, maintenance, and removal of all erosion and sedimentation controls. All preventative and remedial maintenance work, including clean out repair, replacement,

performed immediately. Sediment that has been trapped by the silt soxx will be removed as required, and in all cases, before the accumulation has reached half the height of the BMP. Compost filter sock will be re-anchored, repaired, or replaced as necessary. All other controls will be inspected on the same schedule. If erosion and sediment control BMPs fail to perform as expected, replacement BMPs, or modification of those installed will be

5.3 Removal of Controls and Continuing Maintenance

1. All required temporary erosion and sedimentation controls shall remain in place and be maintained until the area they protect has

2. An area shall be considered to have achieved final stabilization when it has a minimum uniform 70% perennial vegetative cover or other permanent non-vegetative cover with a density sufficient to resist accelerated surface erosion and subsurface characteristics sufficient to resist sliding or other movements.

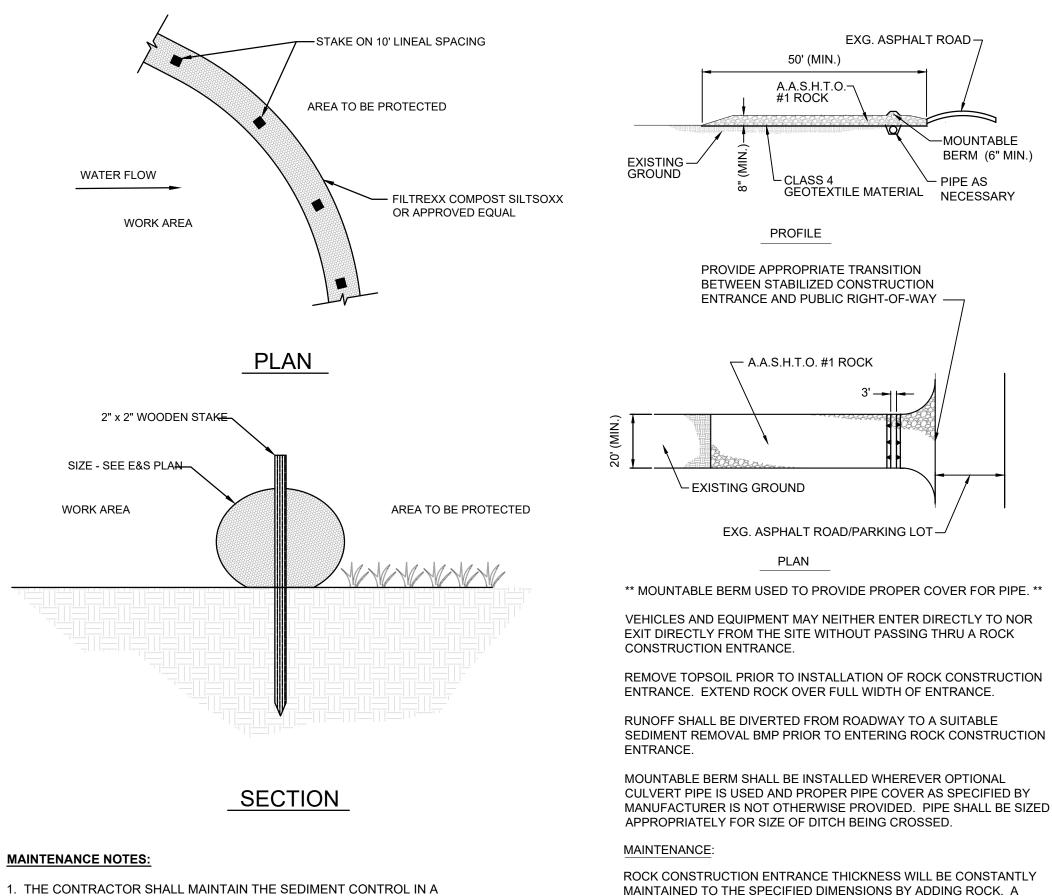

FUNCTIONAL CONDITION AT ALL TIMES AND IT SHALL BE ROUTINELY INSPECTED.

3. THE CONTRACTOR SHALL REMOVE SEDIMENT AT THE BASE OF THE UPSLOPE SIDE

ENGINEER. ALTERNATIVELY, A NEW SEDIMENT CONTROL CAN BE PLACED ON TOP

DEVICE HAS BEEN PERMANENTLY STABILIZED AND CONSTRUCTION ACTIVITY HAS

5. THE FILTERMEDIA WILL BE DISPERSED ON SITE ONCE DISTURBED AREA HAS BEEN

6. FOR LONG-TERM SEDIMENT AND POLLUTION CONTROL APPLICATIONS, SEDIMENT

VEGETATIVE FILTERING SYSTEM FOR PROLONGED AND INCREASED FILTRATION OF

SEDIMENT AND SOLUBLE POLLUTANTS (CONTAINED VEGETATIVE FILTER STRIP).

PERMANENTLY STABILIZED, CONSTRUCTION ACTIVITY HAS CEASED, OR AS

CONTROL CAN BE SEEDED AT THE TIME OF INSTALLATION TO CREATED A

THE APPROPRIATE SEED MIX SHALL BE DETERMINED BY THE ENGINEER.

2. IF THE SEDIMENT CONTROL HAS BEEN DAMAGED, IT SHALL BE REPAIRED, OR

OF THE SEDIMENT CONTROL WHEN ACCUMULATION HAS REACHED ¹/₂ OF THE

EFFECTIVE HEIGHT OF THE SEDIMENT CONTROL, OR AS DIRECTED BY THE

OF AND SLIGHTLY BEHIND THE ORIGINAL ONE CREATING MORE SEDIMENT

4. SEDIMENT CONTROL SHALL BE MAINTAINED UNTIL DISTURBED AREA ABOVE THE

STORAGE CAPACITY WITHOUT SOIL DISTURBANCE.

FILTER SOCK (TYP.)

REPLACED IF BEYOND REPAIR.


DETERMINED BY THE ENGINEER.

NOT TO SCALE

CEASED

ROCK CONSTRUCTION ENTRANCE THICKNESS WILL BE CONSTANTLY MAINTAINED TO THE SPECIFIED DIMENSIONS BY ADDING ROCK. A STOCKPILE OF ROCK MATERIAL WILL BE MAINTAINED ON THE SITE FOR THIS PURPOSE. ALL SEDIMENT DEPOSITED ON PAVED ROADWAYS SHALL BE REMOVED AND RETURNED TO THE CONSTRUCTION SITE IMMEDIATELY. IF EXCESSIVE AMOUNTS OF SEDIMENT ARE BEING DEPOSITED ON ROADWAY, EXTEND LENGTH OF ROCK CONSTRUCTION ENTRANCE BY 50' INCREMENTS UNTIL CONDITION IS ALLEVIATED OR INSTALL WASH RACK. WASHING THE ROADWAY OR SWEEPING THE DEPOSITIS INTO ROADWAY DITCHES, SEWERS, CULVERTS, OR OTHER DRAINAGE COURSES IS NOT ACCEPTABLE.



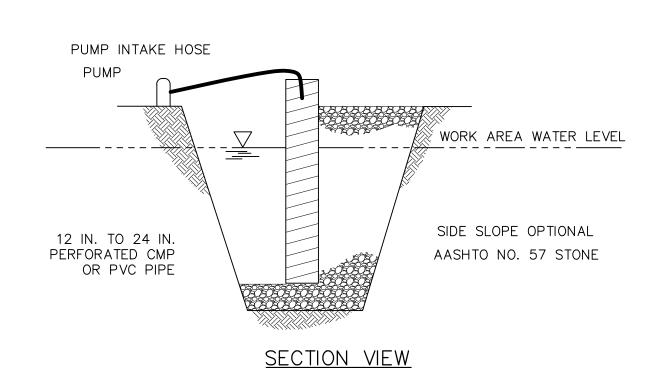

<u>NOTES:</u>

LOCATE SUMP AT LOW POINT IN WORK AREA AND OUTSIDE OF CONSTRUCTION ACTIVITY. WHEREVER RUNOFF FROM A WORK AREA FLOWS DIRECTLY TO THE SUMP AREA, A FILTER BAG SHALL BE ATTACHED AT THE DISCHARGE POINT UNLESS PUMPING TO A SEDIMENT BASIN OR SEDIMENT TRAP.

MINIMUM DIAMETER OF PIT BOTTOM SHALL BE 24" LARGER THAN PIPE DIAMETER. MINIMUM DEPTH OF PIT SHALL BE 24" BELOW WATER LEVEL IN WORK AREA (INCLUDING THE AASHTO #57 STONE). 12" TO 24" PERFORATED CMP OR PVC PIPE SHALL BE SET ON 12" OF CLEAN AASHTO # 57 STONE.


VOID SPACE AROUND PIPE SHALL BE FILLED WITH AASHTO # 57 STONE. PIPE TO EXTEND 12" MIN. ABOVE TOP OF STONE AND/OR WATER BEING PUMPED FROM WORK AREA. SET PUMP INTAKE INSIDE STANDPIPE

DISCHARGE FROM PUMP SHALL BE TO A STABLE AREA BELOW DISTURBANCES FROM THE WORK ZONE.


SUMP MAY BE USED IN CONJUNCTION WITH FILTER BAG WHERE ADDITIONAL FILTERING IS NEEDED. **STANDARD CONSTRUCTION DETAIL #3-17** SUMP PIT

DE-WATERING DETAIL - SUM PIT (TYP.) C.3.1 NOT TO SCALE



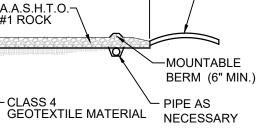



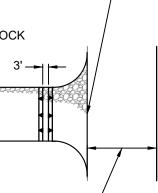


EXG. ASPHALT ROAD/PARKING LOT -

** MOUNTABLE BERM USED TO PROVIDE PROPER COVER FOR PIPE. ** VEHICLES AND EQUIPMENT MAY NEITHER ENTER DIRECTLY TO NOR EXIT DIRECTLY FROM THE SITE WITHOUT PASSING THRU A ROCK


REMOVE TOPSOIL PRIOR TO INSTALLATION OF ROCK CONSTRUCTION


CULVERT PIPE IS USED AND PROPER PIPE COVER AS SPECIFIED BY MANUFACTURER IS NOT OTHERWISE PROVIDED. PIPE SHALL BE SIZED

CONSTRUCTION ENTRANCE (TYP.)

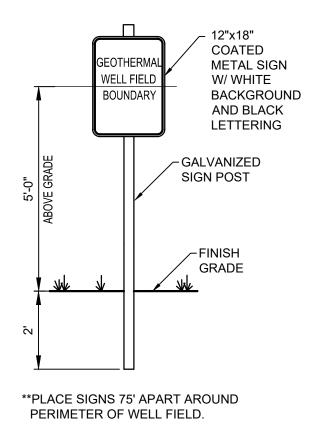



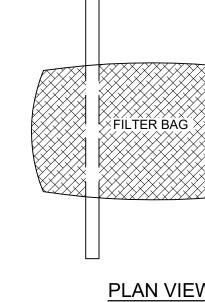

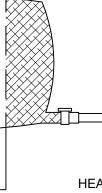

WELL VEGETATED, GRASSY AREA

NOTES

LOW VOLUME FILTER BAGS SHALL BE MAD DOUBLE STITCHED "J" TYPE SEAMS. THEY S VOLUME FILTER BAGS SHALL BE MADE FRO

PROPERTY	TEST METHOD	MINIMUM STA							
AVG. WIDE WIDTH STRENGTH	ASTM D-4884	60 LB/I							
GRAB TENSILE	ASTM D-4632	205 LE							
PUNCTURE	ASTM D-4833	110 LB							
MULLEN BURST	ASTM D-3786	350 PS							
UV RESISTANCE	ASTM D-4355	70%							
AOS % RETAINED	ASTM D-4751	80 SIEV							
A SUITABLE MEANS OF ACCESSING THE BAG WITH MACHINERY REQUIRED FOR I									

SUITABLE MEANS OF ACCESSING THE B FILTER BAGS SHALL BE REPLACED WHEN T REPLACEMENT OF THOSE THAT HAVE FAIL UNLESS BAGS COME WITH LIFTING STRAPS

BAGS SHALL BE LOCATED IN WELL-VEGETA AREAS. WHERE THIS IS NOT POSSIBLE, A G PLACED ON FILTER STONE TO INCREASE D 5%. FOR SLOPES EXCEEDING 5%, CLEAN R UNDER THE BAG TO REDUCE SLOPE STEEP


NO DOWNSLOPE SEDIMENT BARRIER IS RE SHALL BE INSTALLED BELOW BAGS LOCATI WATER OR WHERE GRASSY AREA IS NOT A

THE PUMP DISCHARGE HOSE SHALL BE INS SECURELY CLAMPED. A PIECE OF PVC PIPE THE PUMPING RATE SHALL BE NO GREATE WHICHEVER IS LESS. PUMP INTAKES SHALL

FILTER BAGS SHALL BE INSPECTED DAILY. **RESUME UNTIL THE PROBLEM IS CORRECT**

DE-WATERING NOT TO SCALE


		WELL VEGETATED, GRASSY AREA DISCHARGE HOSE	
	FILTER BAG	CLAMPS PUMP INTAKE HOSE	
Ę			
	PLAN VIE	HEAVY DUTY LIFTING STRAPS (RECOMMENDED)	
		CLAMPS	
TED, GRASSY A	AREA		
-		VIEW OVEN GEOTEXTILE MATERIAL SEWN WITH HIGH STRENGTH, BLE OF TRAPPING PARTICLES LARGER THAN 150 MICRONS. HIGH	
SHALL BE MAE	DE FROM WOVEN GEO TEST METHOD ASTM D-4884	TEXTILES THAT MEET THE FOLLOWING STANDARDS: MINIMUM STANDARD 60 LB/IN	
ILE E RST NCE	ASTM D-4632 ASTM D-4833 ASTM D-3786 ASTM D-4355	205 LB 110 LB 350 PSI 70%	
ACCESSING T	ASTM D-4751 HE BAG WITH MACHIN HEN THEY BECOME 1/	80 SIEVE ERY REQUIRED FOR DISPOSAL PURPOSES SHALL BE PROVIDED 2 FULL OF SEDIMENT. SPARE BAGS SHALL BE KEPT AVAILABLE F ED. BAGS SHALL BE PLACED ON STRAPS TO FACILITATE REMOVA	OR
ED IN WELL-VE NOT POSSIBL	.E, A GEOTÈXTILE UŃD	CHED. AREA, AND DISCHARGE ONTO STABLE, EROSION RESISTANT ERLAYMENT AND FLOW PATH SHALL BE PROVIDED. BAGS MAY E ACITY. BAGS SHALL NOT BE PLACED ON SLOPES GREATER THAN	
DUCE SLOPE	STEEPNESS.	NON-ERODIBLE AND NON-POLLUTING MATERIAL MAY BE PLACED OST INSTALLATIONS. COMPOST BERM OR COMPOST FILTER SOC WATERSHEDS, WITHIN 50 FEET OF ANY RECEIVING SURFACE	
ASSY AREA IS HOSE SHALL	NOT AVAILABLE. BE INSERTED INTO TH	E BAGS IN THE MANNER SPECIFIED BY THE MANUFACTURER AN DED FOR THIS PURPOSE.	D
UMP INTAKES	SHALL BE FLOATING A	OR 1/2 THE MAXIMUM SPECIFIED BY THE MANUFACTURER, ND SCREENED. I IS DETECTED, PUMPING SHALL CEASE IMMEDIATELY AND NOT	
OBLEM IS COF	RECTED. DARD CONS	TRUCTION DETAIL #3-16 TER FILTER BAG	
TERINO SCALE		PUMPED FILTER BAG (TYP.)	
		NO. DESCRIPTION REVISIONS	DATE
		Professional's Signature Date	
		COMMONWEALTH OF PENNSYLV DEPT. OF MILITARY & VETERAN'S AF ANNVILLE, PENNSYLVANIA 17003	
		COMMONWEALTH OF PENNSYLV DEPT. OF MILITARY & VETERAN'S AF ANNVILLE, PENNSYLVANIA 17003 DESIGN PROFESSIONALS: OFFICE OF FACILITIES AND ENGINEERING BUREAU OF DESIGN AND PROJECT MANAGEM BLDG. 0-10, FORT INDIANTOWN GAP ANNVILLE, LEBANON COUNTY, PENNSYLVANIA	FAIRS
		COMMONWEALTH OF PENNSYLV DEPT. OF MILITARY & VETERAN'S AF ANNVILLE, PENNSYLVANIA 17003 DESIGN PROFESSIONALS: OFFICE OF FACILITIES AND ENGINEERING BUREAU OF DESIGN AND PROJECT MANAGEM BLDG. 0-10, FORT INDIANTOWN GAP ANNVILLE, LEBANON COUNTY, PENNSYLVANIA PROJECT NO.: 420591 (888 BLDG. 11-89 TISA	FAIRS ENT 321)
BAR IS ON	FY SCALE	COMMONWEALTH OF PENNSYLV DEPT. OF MILITARY & VETERAN'S AF ANNVILLE, PENNSYLVANIA 17003 DESIGN PROFESSIONALS: OFFICE OF FACILITIES AND ENGINEERING BUREAU OF DESIGN AND PROJECT MANAGEM BLDG. 0-10, FORT INDIANTOWN GAP ANNVILLE, LEBANON COUNTY, PENNSYLVANIA PROJECT NO.: 420591 (888	FAIRS
BAR IS ON ON ORIG 0 IF BAR IS NOT ADJUST SC	NE (1) INCH LONG GINAL DRAWING: 1 ONE (1) INCH LONG, ALE ACCORDINGLY	COMMONWEALTH OF PENNSYLV DEPT. OF MILITARY & VETERAN'S AF ANNVILLE, PENNSYLVANIA 17003 DESIGN PROFESSIONALS: OFFICE OF FACILITIES AND ENGINEERING BUREAU OF DESIGN AND PROJECT MANAGEM BLDG. 0-10, FORT INDIANTOWN GAP ANNVILLE, LEBANON COUNTY, PENNSYLVANIA PROJECT NO.: 420591 (888 BLDG. 11-89 TISA ENERGY UPGRADES AREA 11, FT INDINATOWN GAP, EAST HANOVEF LEBANON COUNTY, PENNSYLVANIA 17003 E&S NOTES AND DETAIL	FAIRS ENT 321) R TWP.
BAR IS ON ON ORIG 0 IF BAR IS NOT ADJUST SC. CONTRACTOR ALL E VARIANCE DOCUMENT WITHOUT BUR	NE (1) INCH LONG GINAL DRAWING: 1 ONE (1) INCH LONG,	COMMONWEALTH OF PENNSYLV DEPT. OF MILITARY & VETERAN'S AF ANNVILLE, PENNSYLVANIA 17003 DESIGN PROFESSIONALS: OFFICE OF FACILITIES AND ENGINEERING BUREAU OF DESIGN AND PROJECT MANAGEM BLDG. 0-10, FORT INDIANTOWN GAP ANNVILLE, LEBANON COUNTY, PENNSYLVANIA PROJECT NO.: 420591 (888 BLDG. 11-89 TISA ENERGY UPGRADES AREA 11, FT INDINATOWN GAP, EAST HANOVEF LEBANON COUNTY, PENNSYLVANIA 1700	FAIRS ENT 321) R TWP.

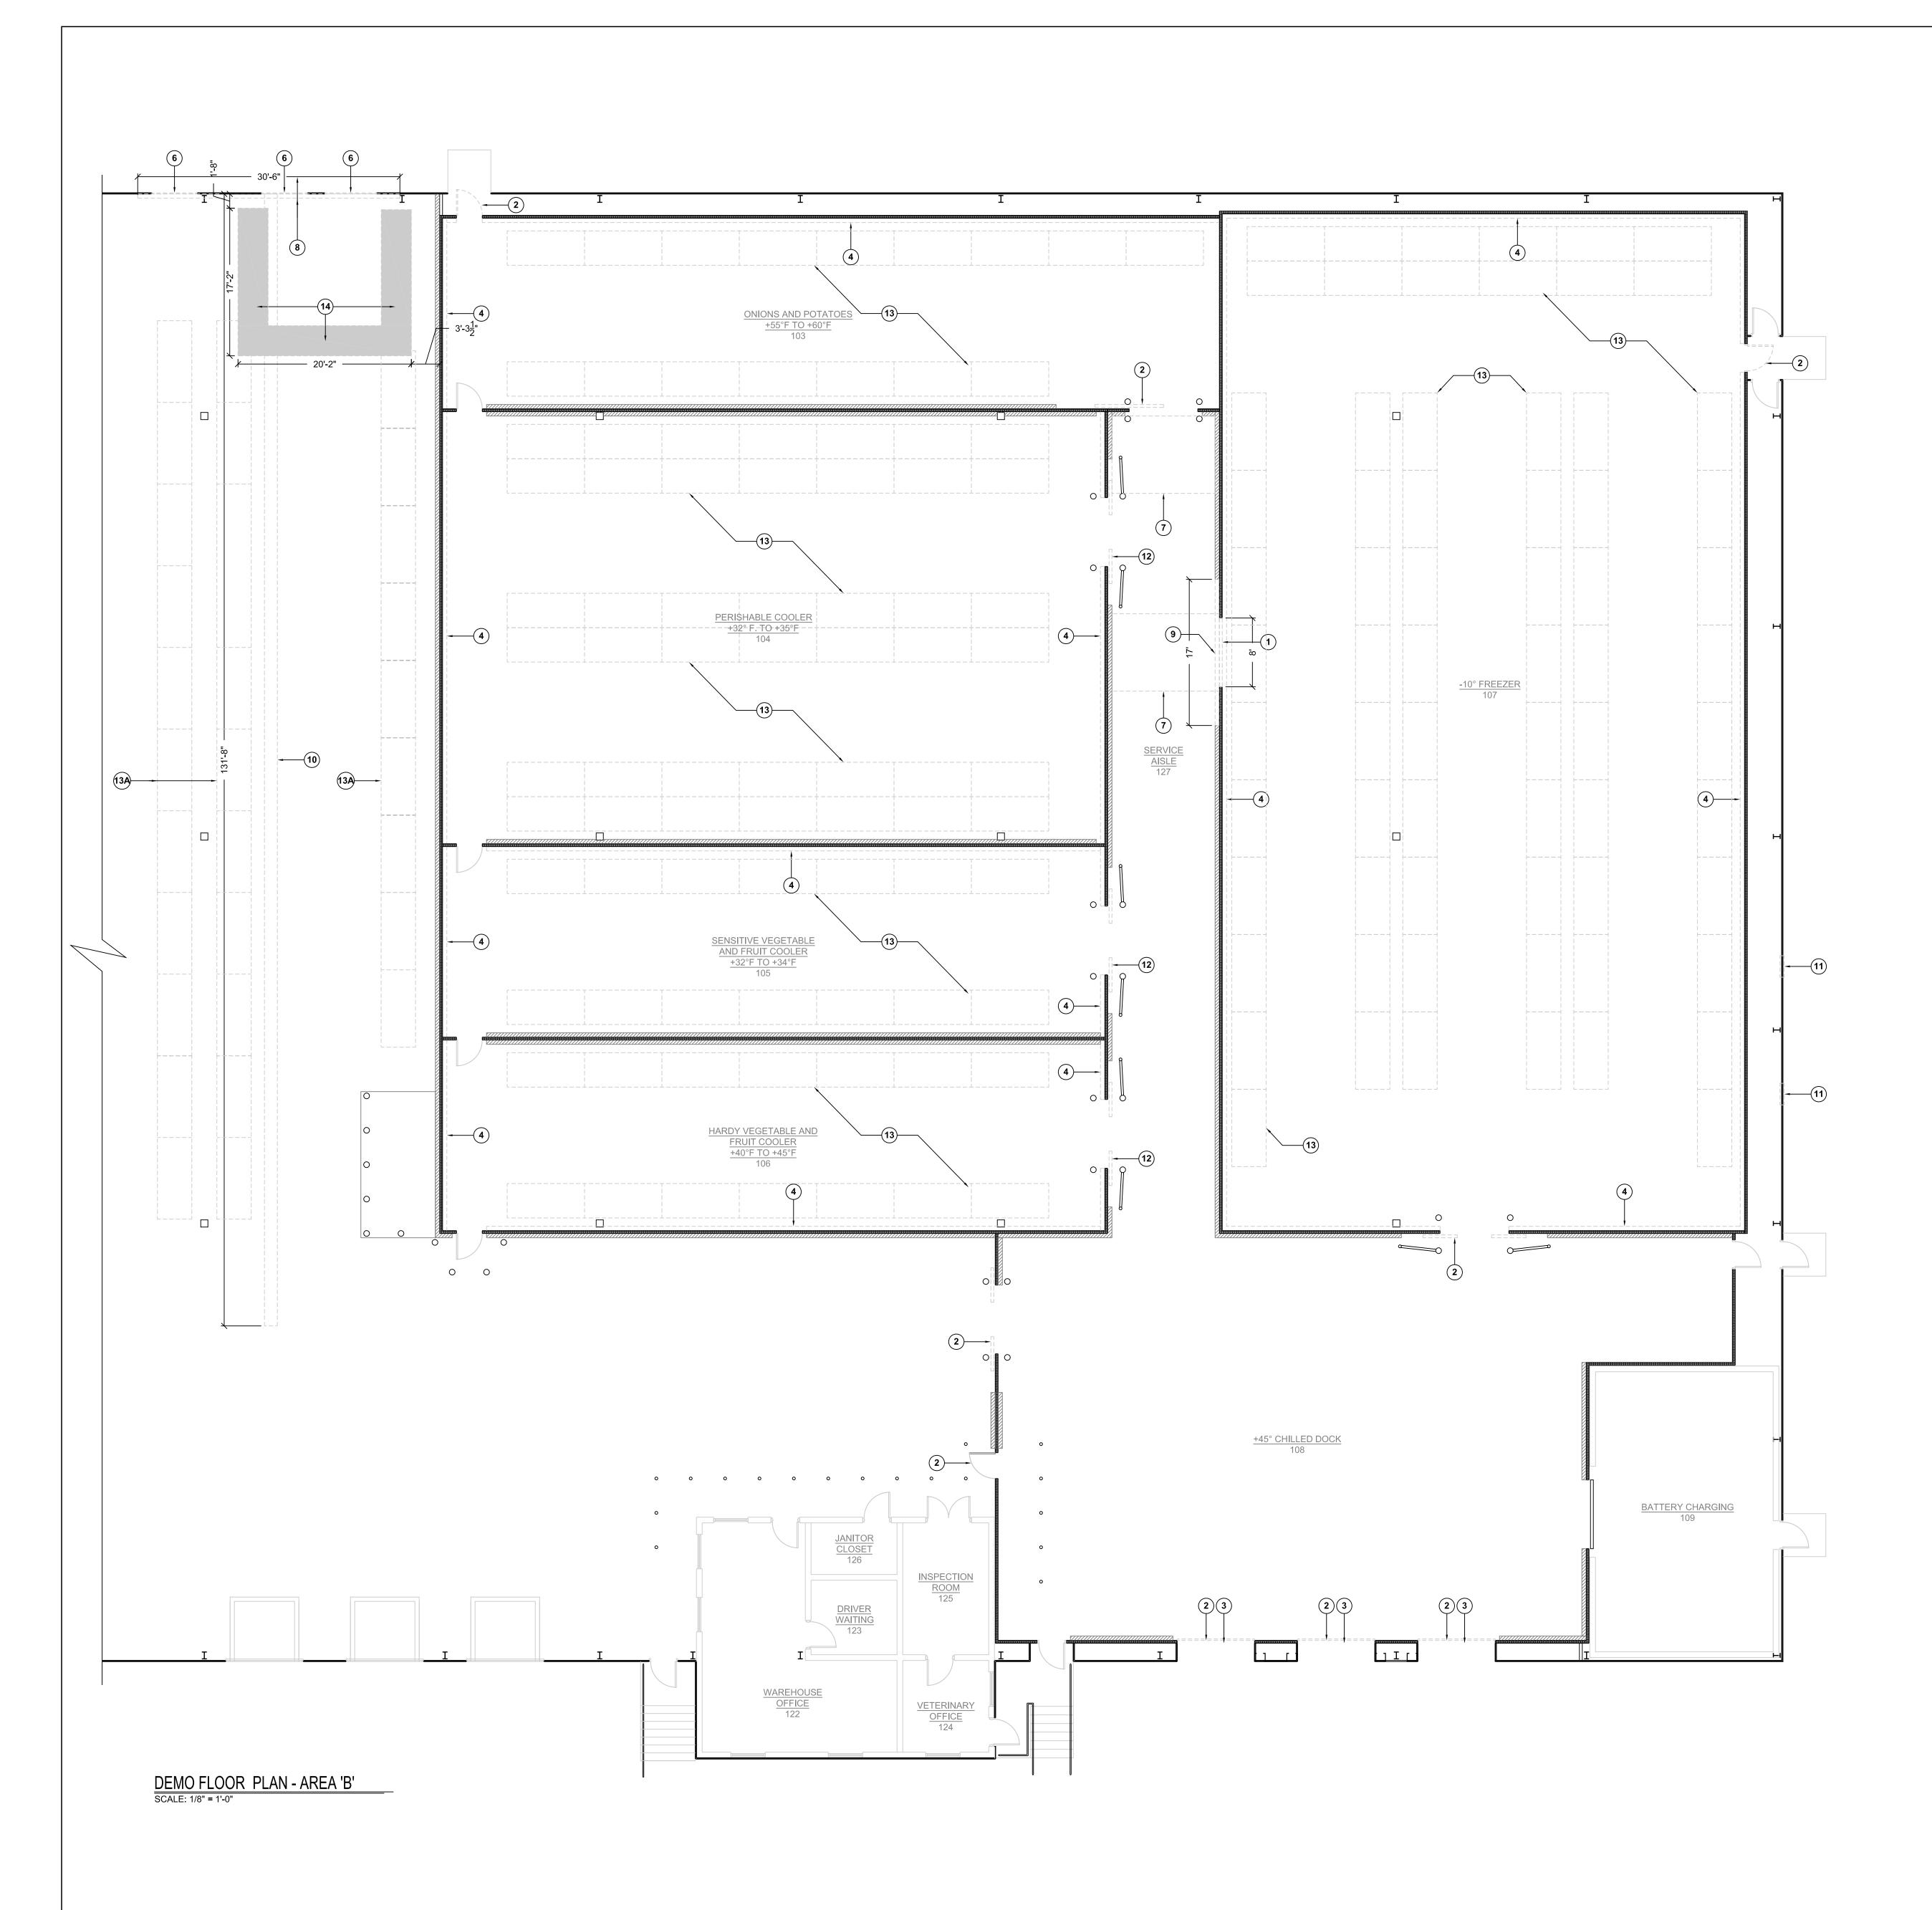


- GENERAL DEMOLITION NOTES . UNLESS STATED OTHERWISE WITHIN THE PROJECT DESIGN DOCUMENTS, THE GENERAL CONTRACTOR (.1) IS RESPONSIBLE FOR THE DEMOLITION WORK AS DEPICTED ON THIS PLAN AND THROUGHOUT ANY ADDITIONAL PROJECT DESIGN DOCUMENTS.
- 2. ALL MATERIALS AND DEBRIS ASSOCIATED WITH THE DEMOLITION OF THE EXISTING FACILITY BECOMES THE SOLE PROPERTY AND RESPONSIBILITY OF THE CONTRACTOR. EXCEPT FOR ALL RECYCLABLE MATERIALS SHALL BE RETURNED TO THE DEPARTMENT.
- CONTRACTOR SHALL BE RESPONSIBLE FOR PROPER DISPOSAL OF ALL CONSTRUCTION DEBRIS AND MATERIALS.
 CONCRETE SPOILS TO BE TRANSPORTED OFF-SITE.
- CONTRACTOR SHALL PROVIDE DUMPSTERS AND OTHER DISPOSAL APPURTENANCES NEEDED FOR THE DEMOLITION PHASE OF THIS PROJECT.
 COOLER/FREEZER WALLS NEED TO BE TEMPORARILY SUPPORTED DURING CEILING PANEL
- DEMOLITION AND INSTALL.
- 6. REFER TO 'CEILING PANEL SUPPORT DETAIL' AND 'SPRINKLER HEAD PENETRATION DETAIL' ON DWG. A.3.2.

	KEYED DEMOLITION NOTES									
1										
2	2 REMOVE DOOR, FRAME/TRACK AND ASSOCIATED ITEMS.									
3	3 REMOVE DOCK SEALS, HEAD PADS AND ASSOCIATED ITEMS.									
4	EXISTING CONDITIONS' DETAIL ON DWG. A.3.1.									
5	REMOVE CONCRETE GUARD POSTS. FOR EXISTING CONDITIONS REFER TO DETAILS ON DWG. A.3.2.									
6	REMOVE PORTION OF METAL WALL PANEL AND VINYL FACED INSULATION IN PREPARATION FOR NEW DOOR/EXPLOSION RELIEF VENT OPENINGS.									
7	GRIND AND REMOVE CONCRETE AND ASSOCIATED ITEMS IN THIS AREA IN PREPARATION FOR NEW IN FLOOR HEATING PAD. REFER TO DETAIL ON DWG. A.3.2 FOR DEPTH.									
8	REMOVE CONCRETE CURB AND ASSOCIATED ITEMS IN PREPARATION FOR NEW CONSTRUCTION. REFER TO 'CONCRETE CURB - EXISTING CONDITIONS' DETAIL ON DWG. A.3.1.									
9	REMOVE 17'-0" +/- OF CONCRETE CURB (AISLE SIDE) AND ASSOCIATED ITEMS FOR NEW FREEZER DOOR OPENING. REFER TO 'CONCRETE CURB - EXISTING CONDITIONS' DETAIL ON DWG. A.3.1.									
10	SAW CUT EXISTING CONCRETE SLAB; 18" WIDE BY DIMENSION SHOWN ON PLAN FOR PLUMBING TRENCH. EXCAVATE EXISTING SUBSTRATE MATERIALS TO DEPTH SHOWN ON 'TRENCH DETAIL.' COORDINATE WITH .3 CONTRACTOR.									
11	REMOVE EXISTING STEEL FRAME FOR LOUVER, RELOCATE ABOVE FIRST GIRT; .2 CONTRACTOR TO REMOVE LOUVER AND REMOUNT IN NEW FRAME LOCATION.									
12	BASE BID 3: REMOVE DOOR, FRAME/TRACK AND ASSOCIATED ITEMS.									
13	REMOVE AND REINSTALL SHELVING RACKS. RACKS TO BE STORED IN AREA 'A' - FINAL LOCATION TO BE DETERMINED IN THE FIELD. COORDINATE WITH FIRE PROTECTION CONTRACTOR PRIOR TO REMOVAL.									
13A	REMOVE SHELVING RACKS, RETURN TO THE DEPARTMENT. COORDINATE WITH FIRE PROTECTION CONTRACTOR PRIOR TO REMOVAL.									
14	SAW CUT EXISTING CONCRETE SLAB; 3'-6" WIDE BY DIMENSIONS SHOWN ON PLAN FOR FOOTER. EXCAVATE EXISTING SUBSTRATE MATERIALS TO DEPTH SHOWN ON 'FOOTER DETAIL.' REFER TO 'FOOTER PLAN' AND 'FOOTER DETAIL' ON DWG. S.1.1.									



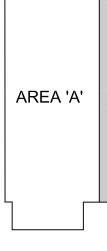

KEY PLAN

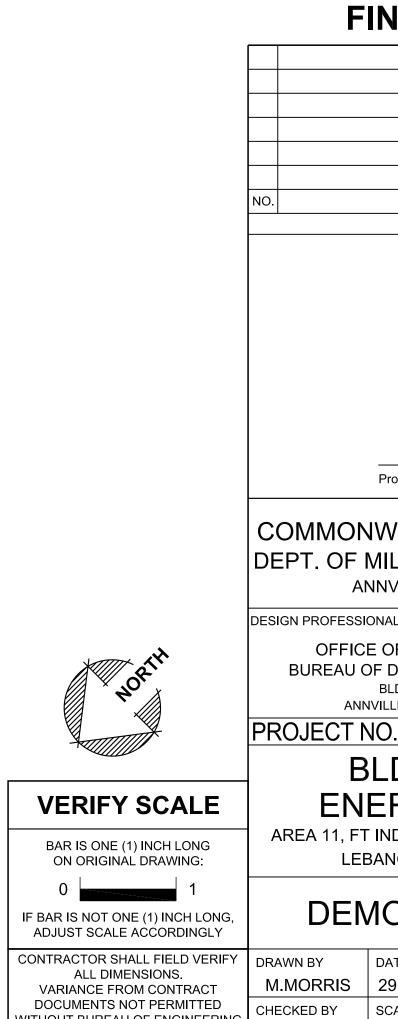

J. NYE


WITHOUT BUREAU OF ENGINEERING AND ARCHITECTURE APPROVAL.

AREA 'B'	
AREA B	
NAL DESIGN	
DESCRIPTION REVISIONS	DATE
Professional's Signature Date	
WEALTH OF PENNSYL IILITARY & VETERAN'S AF NVILLE, PENNSYLVANIA 17003 NALS: OF FACILITIES AND ENGINEERING DESIGN AND PROJECT MANAGEM	FAIRS
BLDG. 0-10, FORT INDIANTOWN GAP ILLE, LEBANON COUNTY, PENNSYLVANIA D.: 420591(888 DG. 11-89 TISA ERGY UPGRADES NDIANTOWN GAP, EAST HANOVEL ANON COUNTY, PENNSYLVANIA	
O PLAN - AREA 'E DATE 29 APR 2024 SCALE AS NOTED	




- GENERAL DEMOLITION NOTES 1. UNLESS STATED OTHERWISE WITHIN THE PROJECT DESIGN DOCUMENTS, THE GENERAL CONTRACTOR (.1) IS RESPONSIBLE FOR THE DEMOLITION WORK AS DEPICTED ON THIS PLAN AND THROUGHOUT ANY ADDITIONAL PROJECT DESIGN DOCUMENTS.
- 2. ALL MATERIALS AND DEBRIS ASSOCIATED WITH THE DEMOLITION OF THE EXISTING FACILITY BECOMES THE SOLE PROPERTY AND RESPONSIBILITY OF THE CONTRACTOR. EXCEPT FOR ALL RECYCLABLE MATERIALS SHALL BE RETURNED TO THE DEPARTMENT.
- 3. CONTRACTOR SHALL BE RESPONSIBLE FOR PROPER DISPOSAL OF ALL CONSTRUCTION DEBRIS AND MATERIALS. 3.1. CONCRETE SPOILS TO BE TRANSPORTED OFF-SITE.
- 4. CONTRACTOR SHALL PROVIDE DUMPSTERS AND OTHER DISPOSAL APPURTENANCES NEEDED FOR THE DEMOLITION PHASE OF THIS PROJECT.
- 5. COOLER/FREEZER WALLS NEED TO BE TEMPORARILY SUPPORTED DURING CEILING PANEL DEMOLITION AND INSTALL.
- 6. REFER TO 'CEILING PANEL SUPPORT DETAIL' AND 'SPRINKLER HEAD PENETRATION DETAIL' ON DWG. A.3.2.

KEYED CEILING DEMOLITION NOTES 1 REMOVE INSULATED CEILING PANELS AND ASSOCIATED ITEMS. 2 REMOVE CEILING PANEL HANGERS, THREADED RODS AND ASSOCIATED ITEMS.

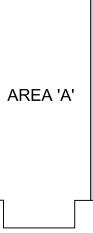

	TRUCTION DEBRIS AND		
	IANCES NEEDED FOR		
	ΓΕ S		
	MS.		
		AREA 'A' AREA 'B'	
FINAL DESIGN Image: Strature NO DESCRIPTION DESCRIPTION DATE NO DESCRIPTION DESCRIPTION DATE DESCRIPTION DESCRIPTION DESCRIPTION DESCRIPTION DESCRIPTION COMMONICATION OF DESCRIPTION OF DESCRIPTION OF TRANSACEMENT DENDESCRIPTION EDESCRIPTION DESCRIPTION EDESCRIPTION DESCRIPTION EDESCRIPTION DESCRIPTION EDESCRIPTION DESCRIPTION EDESCRIPTION DESCRIPTION EDESCRIPTION			
Image: Stress of the second stress of the		NUT TO SCALE	
Image: Stress of the second stress of the			
REVISIONS REVISIONS REVISIONS Professional's Signature Date COMMONWEALTH OF PENNSYLVANIA DEFICE OF FACILITIES AND ENGINEERING DEFICE OF FACILITIES AND ENGINEERING DESIGN PROFESSIONALS: OFFICE OF FACILITIES AND ENGINEERING DESIGN PROFESSIONALS: OFFICE OF FACILITIES AND ENGINEERING BUDG. 0-10, FORT INDIANTOWN GAP BUDG. 0-10, FORT INDIANTOWN GAP ANNVILLE, LEBANON COUNTY, PENNSYLVANIA PROJECT NO.: 420591 (88821) BLDG. 11-89 TISA ENERGY UPGRADES AREA 11, FT INDIANTOWN GAP, EAST HANOVER TWP LEBANON COUNTY, PENNSYLVANIA DEMO CLG. PLAN - AREA 'B' ORITRACT OR SHALL FIELD VERIFY ALL DIMENSIONS, VARIANCE FROM CONTRACT DOCUMENTS NOT PERMITTER VERIFUSICALE ACCORDINGLY ORAVINEY DATE MICHOLT BURGAUGE REGNINEERING DOCUMENTS NOT PERMITTER DATE DATE		FINAL DESIGN	
REVISIONS REVISIONS REVISIONS Professional's Signature Date COMMONWEALTH OF PENNSYLVANIA DEFICE OF FACILITIES AND ENGINEERING DEFICE OF FACILITIES AND ENGINEERING DESIGN PROFESSIONALS: OFFICE OF FACILITIES AND ENGINEERING DESIGN PROFESSIONALS: OFFICE OF FACILITIES AND ENGINEERING BUDG. 0-10, FORT INDIANTOWN GAP BUDG. 0-10, FORT INDIANTOWN GAP ANNVILLE, LEBANON COUNTY, PENNSYLVANIA PROJECT NO.: 420591 (88821) BLDG. 11-89 TISA ENERGY UPGRADES AREA 11, FT INDIANTOWN GAP, EAST HANOVER TWP LEBANON COUNTY, PENNSYLVANIA DEMO CLG. PLAN - AREA 'B' ORITRACT OR SHALL FIELD VERIFY ALL DIMENSIONS, VARIANCE FROM CONTRACT DOCUMENTS NOT PERMITTER VERIFUSICALE ACCORDINGLY ORAVINEY DATE MICHOLT BURGAUGE REGNINEERING DOCUMENTS NOT PERMITTER DATE DATE			
REVISIONS REVISIONS REVISIONS Professional's Signature Date COMMONWEALTH OF PENNSYLVANIA DEFICE OF FACILITIES AND ENGINEERING DEFICE OF FACILITIES AND ENGINEERING DESIGN PROFESSIONALS: OFFICE OF FACILITIES AND ENGINEERING DESIGN PROFESSIONALS: OFFICE OF FACILITIES AND ENGINEERING BUDG. 0-10, FORT INDIANTOWN GAP BUDG. 0-10, FORT INDIANTOWN GAP ANNVILLE, LEBANON COUNTY, PENNSYLVANIA PROJECT NO.: 420591 (88821) BLDG. 11-89 TISA ENERGY UPGRADES AREA 11, FT INDIANTOWN GAP, EAST HANOVER TWP LEBANON COUNTY, PENNSYLVANIA DEMO CLG. PLAN - AREA 'B' ORITRACT OR SHALL FIELD VERIFY ALL DIMENSIONS, VARIANCE FROM CONTRACT DOCUMENTS NOT PERMITTER VERIFUSICALE ACCORDINGLY ORAVINEY DATE MICHOLT BURGAUGE REGNINEERING DOCUMENTS NOT PERMITTER DATE DATE			
REVISIONS REVISIONS REVISIONS Professional's Signature Date COMMONWEALTH OF PENNSYLVANIA DEFICE OF FACILITIES AND ENGINEERING DEFICE OF FACILITIES AND ENGINEERING DESIGN PROFESSIONALS: OFFICE OF FACILITIES AND ENGINEERING DESIGN PROFESSIONALS: OFFICE OF FACILITIES AND ENGINEERING BUDG. 0-10, FORT INDIANTOWN GAP BUDG. 0-10, FORT INDIANTOWN GAP ANNVILLE, LEBANON COUNTY, PENNSYLVANIA PROJECT NO.: 420591 (88821) BLDG. 11-89 TISA ENERGY UPGRADES AREA 11, FT INDIANTOWN GAP, EAST HANOVER TWP LEBANON COUNTY, PENNSYLVANIA DEMO CLG. PLAN - AREA 'B' ORITRACT OR SHALL FIELD VERIFY ALL DIMENSIONS, VARIANCE FROM CONTRACT DOCUMENTS NOT PERMITTER VERIFUSICALE ACCORDINGLY ORAVINEY DATE MICHOLT BURGAUGE REGNINEERING DOCUMENTS NOT PERMITTER DATE DATE			
Professional's Signature Date COMMONWEALTH OF PENNSYLVANIA DEPT. OF MILITARY & VETERAN'S AFFAIR: ANNVILLE, PENNSYLVANIA 17003 DESIGN PROFESSIONALS: OFFICE OF FACILITIES AND ENGINEERING BUREAU OF DESIGN AND PROJECT MANAGEMENT BLDG. 0:10, FORT INDIANTOWN GAP ANNVILLE, LEBANON COUNTY, PENNSYLVANIA PROJECT NO: 420591(88821) BLDG. 11-89 TISA ENERGY UPGRADES AREA 11, FT INDIANTOWN GAP, EAST HANOVER TWP LEBANON COUNTY, PENNSYLVANIA 0 1 IF BAR IS NOT ONE (1) INCH LONG, ADJUST SCALE ACORDINGLY DEMO CLG. PLAN - AREA 'B' OCONTRACTOR SHALL FIELD VERIFY ALL DIMENSIONS, VARIANCE FROM CONTRACT DOCUMENTS NOT PERMITTING DRAWN BY MANORRIS 29 APR 2024 DRAWING NO. OWNERS TO TERMITTER DEMONCE FROM CONTRACT DOCUMENTS NOT PERMITTER CONTRACT DOCUMENTS NOT PERMITTER DEMONCE FROM CONTRACT DOCUMENTS NOT PERMITTER CONTRACT DOCUMENTS NOT PERMITTER DEMONCE FROM CONTRACT DOCUMENTS NOT PERMITTER DEMONCE FROM CONTRACT DOCUMENTS NOT PERMITTER CHECKED BY DRAWING NO.			DATE
VERIFY SCALE BAR IS ONE (1) INCH LONG ON ORIGINAL DRAWING: 0 1 IF BAR IS NOT ONE (1) INCH LONG ON ORIGINAL DRAWING: 0 1 IF BAR IS NOT ONE (1) INCH LONG ON ORIGINAL DRAWING: 0 1 IF BAR IS NOT ONE (1) INCH LONG ON ORIGINAL DRAWING: 0 1 IF BAR IS NOT ONE (1) INCH LONG ON ORIGINAL DRAWING: 0 1 IF BAR IS NOT ONE (1) INCH LONG ADJUST SCALE ACCORDINGLY CONTRACTOR SHALL FIELD VERIFY ALL DIMENSIONS, VARIANCE FROM CONTRACT DOCUMENTS NOT PERMITTED WITHOUT BUREAU OF ENGINEERING DRAWN BY MILD OF ENGINEERING DATE M.MORRIS DRAWING NO. MMORRIS 29 APR 2024 CHECKED BY DRAWING NO. ADJUST SCALE ACCORDINGLY DRAWN BY M.MORRIS DATE M.MORRIS DRAWING NO.		REVISIONS	
VERIFY SCALE BAR IS ONE (1) INCH LONG ON ORIGINAL DRAWING: 0 1 IF BAR IS NOT ONE (1) INCH LONG ON ORIGINAL DRAWING: 0 1 IF BAR IS NOT ONE (1) INCH LONG ON ORIGINAL DRAWING: 0 1 IF BAR IS NOT ONE (1) INCH LONG ON ORIGINAL DRAWING: 0 1 IF BAR IS NOT ONE (1) INCH LONG ON ORIGINAL DRAWING: 0 1 IF BAR IS NOT ONE (1) INCH LONG ADJUST SCALE ACCORDINGLY CONTRACTOR SHALL FIELD VERIFY ALL DIMENSIONS, VARIANCE FROM CONTRACT DOCUMENTS NOT PERMITTED WITHOUT BUREAU OF ENGINEERING DRAWN BY MILD OF ENGINEERING DATE M.MORRIS DRAWING NO. MMORRIS 29 APR 2024 CHECKED BY DRAWING NO. ADJUST SCALE ACCORDINGLY DRAWN BY M.MORRIS DATE M.MORRIS DRAWING NO.			
VERIFY SCALE BAR IS ONE (1) INCH LONG ON ORIGINAL DRAWING: 0 1 IF BAR IS NOT ONE (1) INCH LONG ON ORIGINAL DRAWING: 0 1 IF BAR IS NOT ONE (1) INCH LONG ON ORIGINAL DRAWING: 0 1 IF BAR IS NOT ONE (1) INCH LONG ON ORIGINAL DRAWING: 0 1 IF BAR IS NOT ONE (1) INCH LONG ON ORIGINAL DRAWING: 0 1 IF BAR IS NOT ONE (1) INCH LONG ADJUST SCALE ACCORDINGLY CONTRACTOR SHALL FIELD VERIFY ALL DIMENSIONS, VARIANCE FROM CONTRACT DOCUMENTS NOT PERMITTED WITHOUT BUREAU OF ENGINEERING DRAWN BY MILD OF ENGINEERING DATE M.MORRIS DRAWING NO. MMORRIS 29 APR 2024 CHECKED BY DRAWING NO. ADJUST SCALE ACCORDINGLY DRAWN BY M.MORRIS DATE M.MORRIS DRAWING NO.			
VERIFY SCALE BAR IS ONE (1) INCH LONG ON ORIGINAL DRAWING: 0 1 IF BAR IS NOT ONE (1) INCH LONG ON ORIGINAL DRAWING: 0 1 IF BAR IS NOT ONE (1) INCH LONG ON ORIGINAL DRAWING: 0 1 IF BAR IS NOT ONE (1) INCH LONG ON ORIGINAL DRAWING: 0 1 IF BAR IS NOT ONE (1) INCH LONG ON ORIGINAL DRAWING: 0 1 IF BAR IS NOT ONE (1) INCH LONG ADJUST SCALE ACCORDINGLY CONTRACTOR SHALL FIELD VERIFY ALL DIMENSIONS, VARIANCE FROM CONTRACT DOCUMENTS NOT PERMITTED WITHOUT BUREAU OF ENGINEERING DRAWN BY MILD OF ENGINEERING DATE M.MORRIS DRAWING NO. MMORRIS 29 APR 2024 CHECKED BY DRAWING NO. ADJUST SCALE ACCORDINGLY DRAWN BY M.MORRIS DATE M.MORRIS DRAWING NO.			
VERIFY SCALE BAR IS ONE (1) INCH LONG ON ORIGINAL DRAWING: 0 1 IF BAR IS NOT ONE (1) INCH LONG ADJUST SCALE ACCORDINGLY CONTRACTOR SHALL FIELD VERIFY ALL DIMENSIONS, VARIANCE FROM CONTRACT DOCUMENTS NOT PERMITTED WITHOUT BUREAU OF ENGINEERING BUREAU OF DESIGN AND PROJECT MANAGEMENT BLDG. 0-10, FORT INDIANTOWN GAP ANNVILLE, LEBANON COUNTY, PENNSYLVANIA DEDIG OF FACILITIES AND ENGINEERING BUREAU OF DESIGN AND PROJECT MANAGEMENT BLDG. 0-10, FORT INDIANTOWN GAP ANNVILLE, LEBANON COUNTY, PENNSYLVANIA PROJECT NO.: 420591(88821) BLDG. 11-89 TISA ENERGY UPGRADES AREA 11, FT INDIANTOWN GAP, EAST HANOVER TWP LEBANON COUNTY, PENNSYLVANIA DEMOO CLG. PLAN - AREEA 'B' M.MORRIS VARIANCE FROM CONTRACT DOCUMENTS NOT PERMITTED WITHOUT BUREAU OF ENGINEERING WITHOUT BUREAU OF ENGINEERING			
VERIFY SCALE BAR IS ONE (1) INCH LONG ON ORIGINAL DRAWING: 0 1 IF BAR IS NOT ONE (1) INCH LONG ADJUST SCALE ACCORDINGLY CONTRACTOR SHALL FIELD VERIFY ALL DIMENSIONS, VARIANCE FROM CONTRACT DOCUMENTS NOT PERMITTED WITHOUT BUREAU OF ENGINEERING BUREAU OF DESIGN AND PROJECT MANAGEMENT BLDG. 0-10, FORT INDIANTOWN GAP ANNVILLE, LEBANON COUNTY, PENNSYLVANIA DEDIG OF FACILITIES AND ENGINEERING BUREAU OF DESIGN AND PROJECT MANAGEMENT BLDG. 0-10, FORT INDIANTOWN GAP ANNVILLE, LEBANON COUNTY, PENNSYLVANIA PROJECT NO.: 420591(88821) BLDG. 11-89 TISA ENERGY UPGRADES AREA 11, FT INDIANTOWN GAP, EAST HANOVER TWP LEBANON COUNTY, PENNSYLVANIA DEMOO CLG. PLAN - AREEA 'B' M.MORRIS VARIANCE FROM CONTRACT DOCUMENTS NOT PERMITTED WITHOUT BUREAU OF ENGINEERING WITHOUT BUREAU OF ENGINEERING			
Image: Contract of the state of the sta		Professional's Signature Date	
Image: Contract of the state of the sta		COMMONWEALTH OF PENNSYLV	ANIA
Design professionals: Design professionals: <td< th=""><th></th><th>DEPT. OF MILITARY & VETERAN'S AFF</th><th></th></td<>		DEPT. OF MILITARY & VETERAN'S AFF	
OFFICE OF FACILITIES AND ENGINEERING BUREAU OF DESIGN AND PROJECT MANAGEMENT BLDG. 0-10, FORT INDIANTOWN GAP ANNVILLE, LEBANON COUNTY, PENNSYLVANIA VERIFY SCALE BAR IS ONE (1) INCH LONG ON ORIGINAL DRAWING: 0 1 IF BAR IS NOT ONE (1) INCH LONG ON ORIGINAL DRAWING: 0 1 IF BAR IS NOT ONE (1) INCH LONG ADJUST SCALE ACCORDINGLY CONTRACTOR SHALL FIELD VERIFY ALL DIMENSIONS. VARIANCE FROM CONTRACT DOCUMENTS NOT PERMITTED WITHOUT BUREAU OF ENGINEERING MARKING FROM CONTRACT DOCUMENTS NOT PERMITTED WITHOUT BUREAU OF ENGINEERING			
BLDG. 0-10, FORT INDIANTOWN GAP ANNVILLE, LEBANON COUNTY, PENNSYLVANIA PROJECT NO.: 420591(88821) BLDG. 0-10, FORT INDIANTOWN GAP VERIFY SCALE BAR IS ONE (1) INCH LONG O 1 IF BAR IS NOT ONE (1) INCH LONG, ADJUST SCALE ACCORDINGLY CONTRACTOR SHALL FIELD VERIFY ALL DIMENSIONS. VARIANCE FROM CONTRACT DOCUMENTS NOT PERMITTED WITHOUT BUREAU OF ENGINEERING	ATTINK NY	OFFICE OF FACILITIES AND ENGINEERING	
VERIFY SCALE PROJECT NO.: 420591(88821) BAR IS ONE (1) INCH LONG ON ORIGINAL DRAWING: BLDG. 11-89 TISA ENERGY UPGRADES 0 1 IF BAR IS NOT ONE (1) INCH LONG, ADJUST SCALE ACCORDINGLY 1 IF BAR IS NOT ONE (1) INCH LONG, ADJUST SCALE ACCORDINGLY 1 OCONTRACTOR SHALL FIELD VERIFY ALL DIMENSIONS. VARIANCE FROM CONTRACT DOCUMENTS NOT PERMITTED WITHOUT BUREAU OF ENGINEERING DRAWN BY DATE MMORRIS 29 APR 2024 DRAWING NO. MIMORRIS 29 APR 2024 AD.1.1	Not Not	BLDG. 0-10, FORT INDIANTOWN GAP	IN I
VERIFY SCALE BAR IS ONE (1) INCH LONG ON ORIGINAL DRAWING: 0 1 IF BAR IS NOT ONE (1) INCH LONG, ADJUST SCALE ACCORDINGLY CONTRACTOR SHALL FIELD VERIFY ALL DIMENSIONS. VARIANCE FROM CONTRACT DOCUMENTS NOT PERMITTED WITHOUT BUREAU OF ENGINEERING DRAWN BY DATE M.MORRIS 29 APR 2024 CHECKED BY SCALE			21)
BAR IS ONE (1) INCH LONG ON ORIGINAL DRAWING: AREA 11, FT INDIANTOWN GAP, EAST HANOVER TWP LEBANON COUNTY, PENNSYLVANIA 0 1 IF BAR IS NOT ONE (1) INCH LONG, ADJUST SCALE ACCORDINGLY 1 CONTRACTOR SHALL FIELD VERIFY ALL DIMENSIONS. VARIANCE FROM CONTRACT DOCUMENTS NOT PERMITTED WITHOUT BUREAU OF ENGINEERING DRAWN BY INCH LONG DRAWN BY CHECKED BY DATE INAMORRIS DRAWING NO.			
BAR IS ONE (I) INCH LONG ON ORIGINAL DRAWING: LEBANON COUNTY, PENNSYLVANIA 0 1 IF BAR IS NOT ONE (1) INCH LONG, ADJUST SCALE ACCORDINGLY 1 CONTRACTOR SHALL FIELD VERIFY ALL DIMENSIONS. VARIANCE FROM CONTRACT DOCUMENTS NOT PERMITTED WITHOUT BUREAU OF ENGINEERING MAR IS ONE (1) INCH LONG, ADJUST SCALE ACCORDINGLY DRAWN BY DEMO CLG. PLAN - AREA 'B' DRAWN BY DATE M.MORRIS 29 APR 2024 CHECKED BY SCALE	VERIFY SCALE		
0 1 IF BAR IS NOT ONE (1) INCH LONG, ADJUST SCALE ACCORDINGLY DEMO CLG. PLAN - AREA 'B' CONTRACTOR SHALL FIELD VERIFY ALL DIMENSIONS. VARIANCE FROM CONTRACT DOCUMENTS NOT PERMITTED WITHOUT BUREAU OF ENGINEERING DRAWN BY M.MORRIS DATE 29 APR 2024 DRAWING NO. M.MORRIS 29 APR 2024 AD.1.1			TWP
ADJUST SCALE ACCORDINGLY CONTRACTOR SHALL FIELD VERIFY ALL DIMENSIONS. VARIANCE FROM CONTRACT DOCUMENTS NOT PERMITTED WITHOUT BUREAU OF ENGINEERING DATE DRAWN BY DATE DRAWING NO. M.MORRIS 29 APR 2024 ADJUST SCALE ACCORDINGLY	0 1		יחי
ALL DIMENSIONS. DATE VARIANCE FROM CONTRACT M.MORRIS DOCUMENTS NOT PERMITTED CHECKED BY WITHOUT BUREAU OF ENGINEERING CHECKED BY	ADJUST SCALE ACCORDINGLY		N N
DOCUMENTS NOT PERMITTED WITHOUT BUREAU OF ENGINEERING CHECKED BY SCALE AD.1.1	ALL DIMENSIONS.	M MORRIS 29 APR 2024	
AND ARCHITECTURE APPROVAL. J. NTE AS NUTED	DOCUMENTS NOT PERMITTED WITHOUT BUREAU OF ENGINEERIN	NG CHECKED BY SCALE AD.1.1	

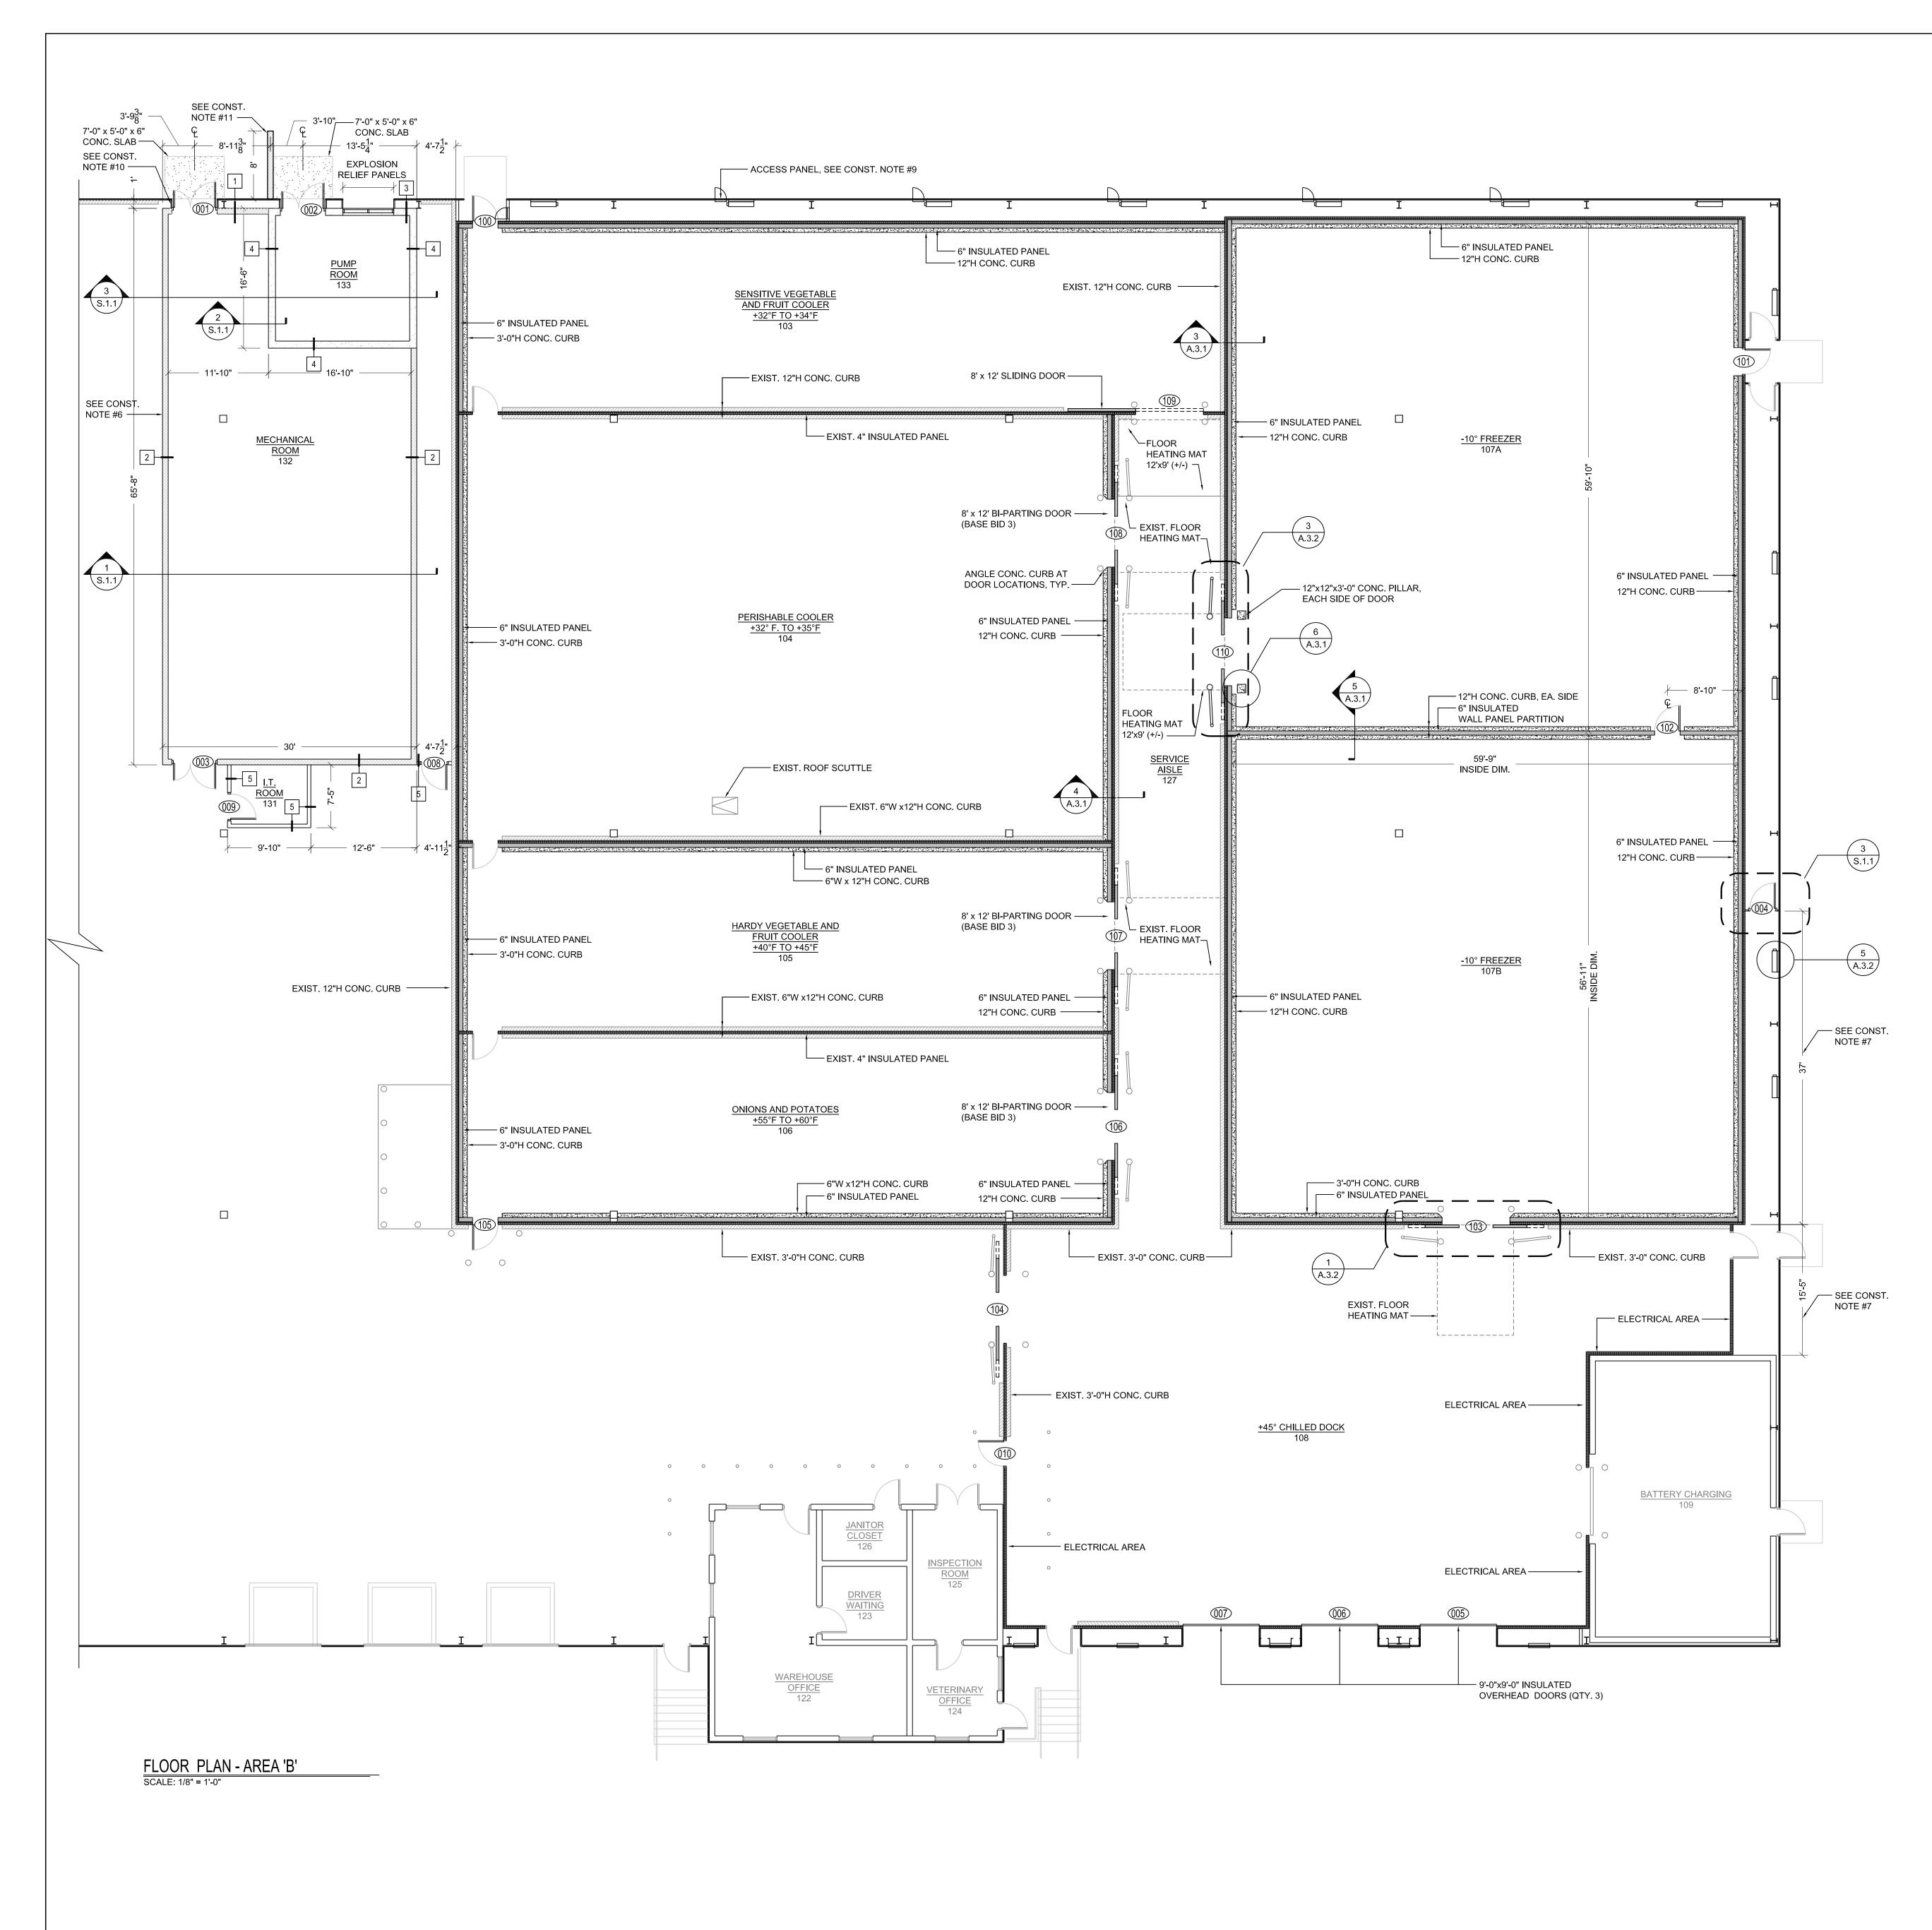


CONSTRUCTION NOTES:

- 1. INSULATED METAL PANEL MANUFACTURER IS RESPONSIBLE FOR PROVIDING WALL AND CEILING PANEL CONNECTIONS, UNLESS SPECIFICALLY NOTED OTHERWISE AND SHALL PROVIDE SHOP DRAWINGS FOR APPROVAL FROM THE DEPARTMENT PRIOR TO STARTING WORK.
- 2. INTERIOR COOLER/FREEZER HEIGHT IS 34'-6"+/-.
- 3. INSTALL CONCRETE CURBING AT ALL NEW WALL PANEL LOCATIONS, TYP. SEE DETAILS ON DWG. A.3.1.
- 4. INSTALL GUARD POSTS AT SLIDING DOOR LOCATIONS, TYP.
- 5. IN-FLOOR HEATING PAD, REFER TO DETAIL ON DWG. A.3.2, AND COORDINATE WITH .4 CONTRACTOR.
- 6. INSTALL SIGNAGE EVERY 6'-0" PERIMETER OF MECHANICAL ROOM 131 WALL. REFER TO SIGN DETAIL ON DWG. A.2.1.
- 7. INSULATE EXTERIOR WALL, REFER TO DETAIL 6 / S.1.1.
- 8. CONTRACTOR SHALL PROVIDE ANCHOR BOLTS AND BEAM CLAMPS FOR INSTALLATION OF COOLER/FREEZER WALL AND CEILING PANELS.
- 9. INSTALL 24x24 (QTY. 6) ACCESS PANELS AS SHOWN ON PLAN 9.1. ACCESS PANELS SHALL BE WATER RESISTANT AND LOCKABLE. 9.2. FRAME AND DOOR PANEL FINISH: 16 GA. GALVANIZED STEEL w/ WHITE PRIME COAT.
- 10. PROVIDE FRAMING, METAL WALL PANELS, TRIM AND ASSOCIATED ITEMS TO FINISH EACH OPENING AT MECHANICAL AND PUMP ROOM LOCATIONS. REFER TO SECTIONS / DETAILS ON DWG. S.1.1.
- 11. CMU WING WALL REFER TO DETAIL ON DWG. S.1.1.


GENERAL NOTES:

- 1. ALL CONTRACTORS SHALL BE AWARE OF THE FACT THA DRAWINGS PROVIDED FOR THIS PROJECT ARE DIAGRAM NATURE AND REQUIRES FIELD VERIFICATION FOR ACTUA CONDITIONS THAT WILL EFFECT PROJECT EXECUTION, E QUANTITIES AND DETAILS. THIS DRAWING SHALL NOT BE FOR DIMENSIONS AND/OR DISTANCES.
- PERFORM ALL WORK IN COMPLIANCE WITH THE APPLICA 2 AND STANDARDS. THE JOB SITE SHALL BE MAINTAINED IN A REASONABLY N 3. ORDERLY CONDITION AND KEPT FREE FROM ACCUMULA WASTE MATERIALS AND RUBBISH DURING THE ENTIRE CONSTRUCTION PERIOD.
- 4. ALL CONTRACTORS SHALL COORDINATE THEIR WORK AN COOPERATE WITH OTHER TRADES.
- LOCATIONS OF ALL ROOF, WALL, AND CEILING 5. PENETRATIONS SHALL BE FIELD VERIFIED BY THE CONTRACTOR.
- ALL REMOVED LOCK CORES SHALL BE RETURNED TO 6 THE DEPARTMENT.
- EACH PRIME CONTRACTOR IS RESPONSIBLE FOR ALL 7 WORK ASSOCIATED WITH ITS OWN TRADE UNLESS SPECIFICALLY INDICATED OTHERWISE.

LEGEND

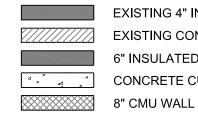


EXISTING 4" INSULATED WALL PANEL EXISTING CONCRETE CURB 6" INSULATED WALL PANEL

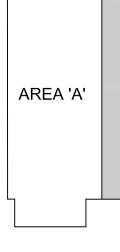


KEY PLAN

FIN

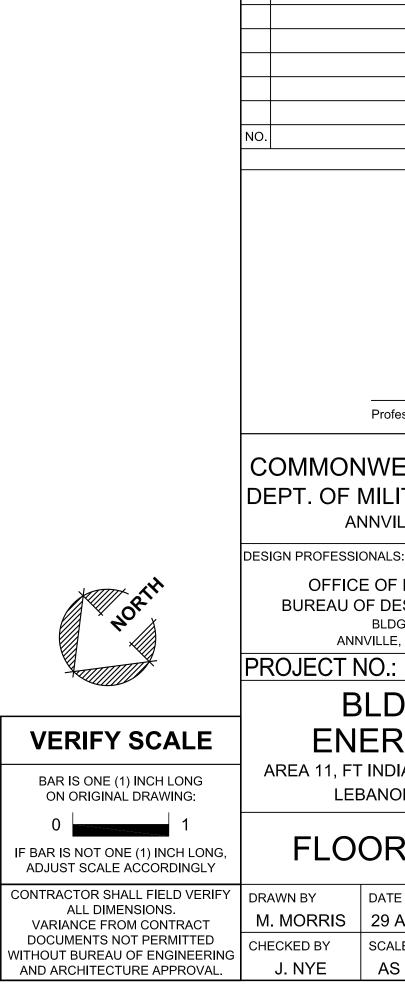

AT ALL MMATIC IN JAL SITE EXACT	
BE SCALED ABLE CODES	
NEAT AND	
ATIONS OF	
AND	
AREA 'B'	
AL DESIGN	
DESCRIPTION REVISIONS	DATE
essional's Signature Date	
EALTH OF PENNSYL\ ITARY & VETERAN'S AF	
ILLE, PENNSYLVANIA 17003	
S: FACILITIES AND ENGINEERING	
ESIGN AND PROJECT MANAGEM DG. 0-10, FORT INDIANTOWN GAP E, LEBANON COUNTY, PENNSYLVANIA	
420591(888 DG. 11-89 TISA	21)
RGY UPGRADES	
IANTOWN GAP, EAST HANOVE ON COUNTY, PENNSYLVANIA	R TWP
R PLAN - AREA 'I	3'
e drawing no. APR 2024 LE A.1.1 S NOTED	

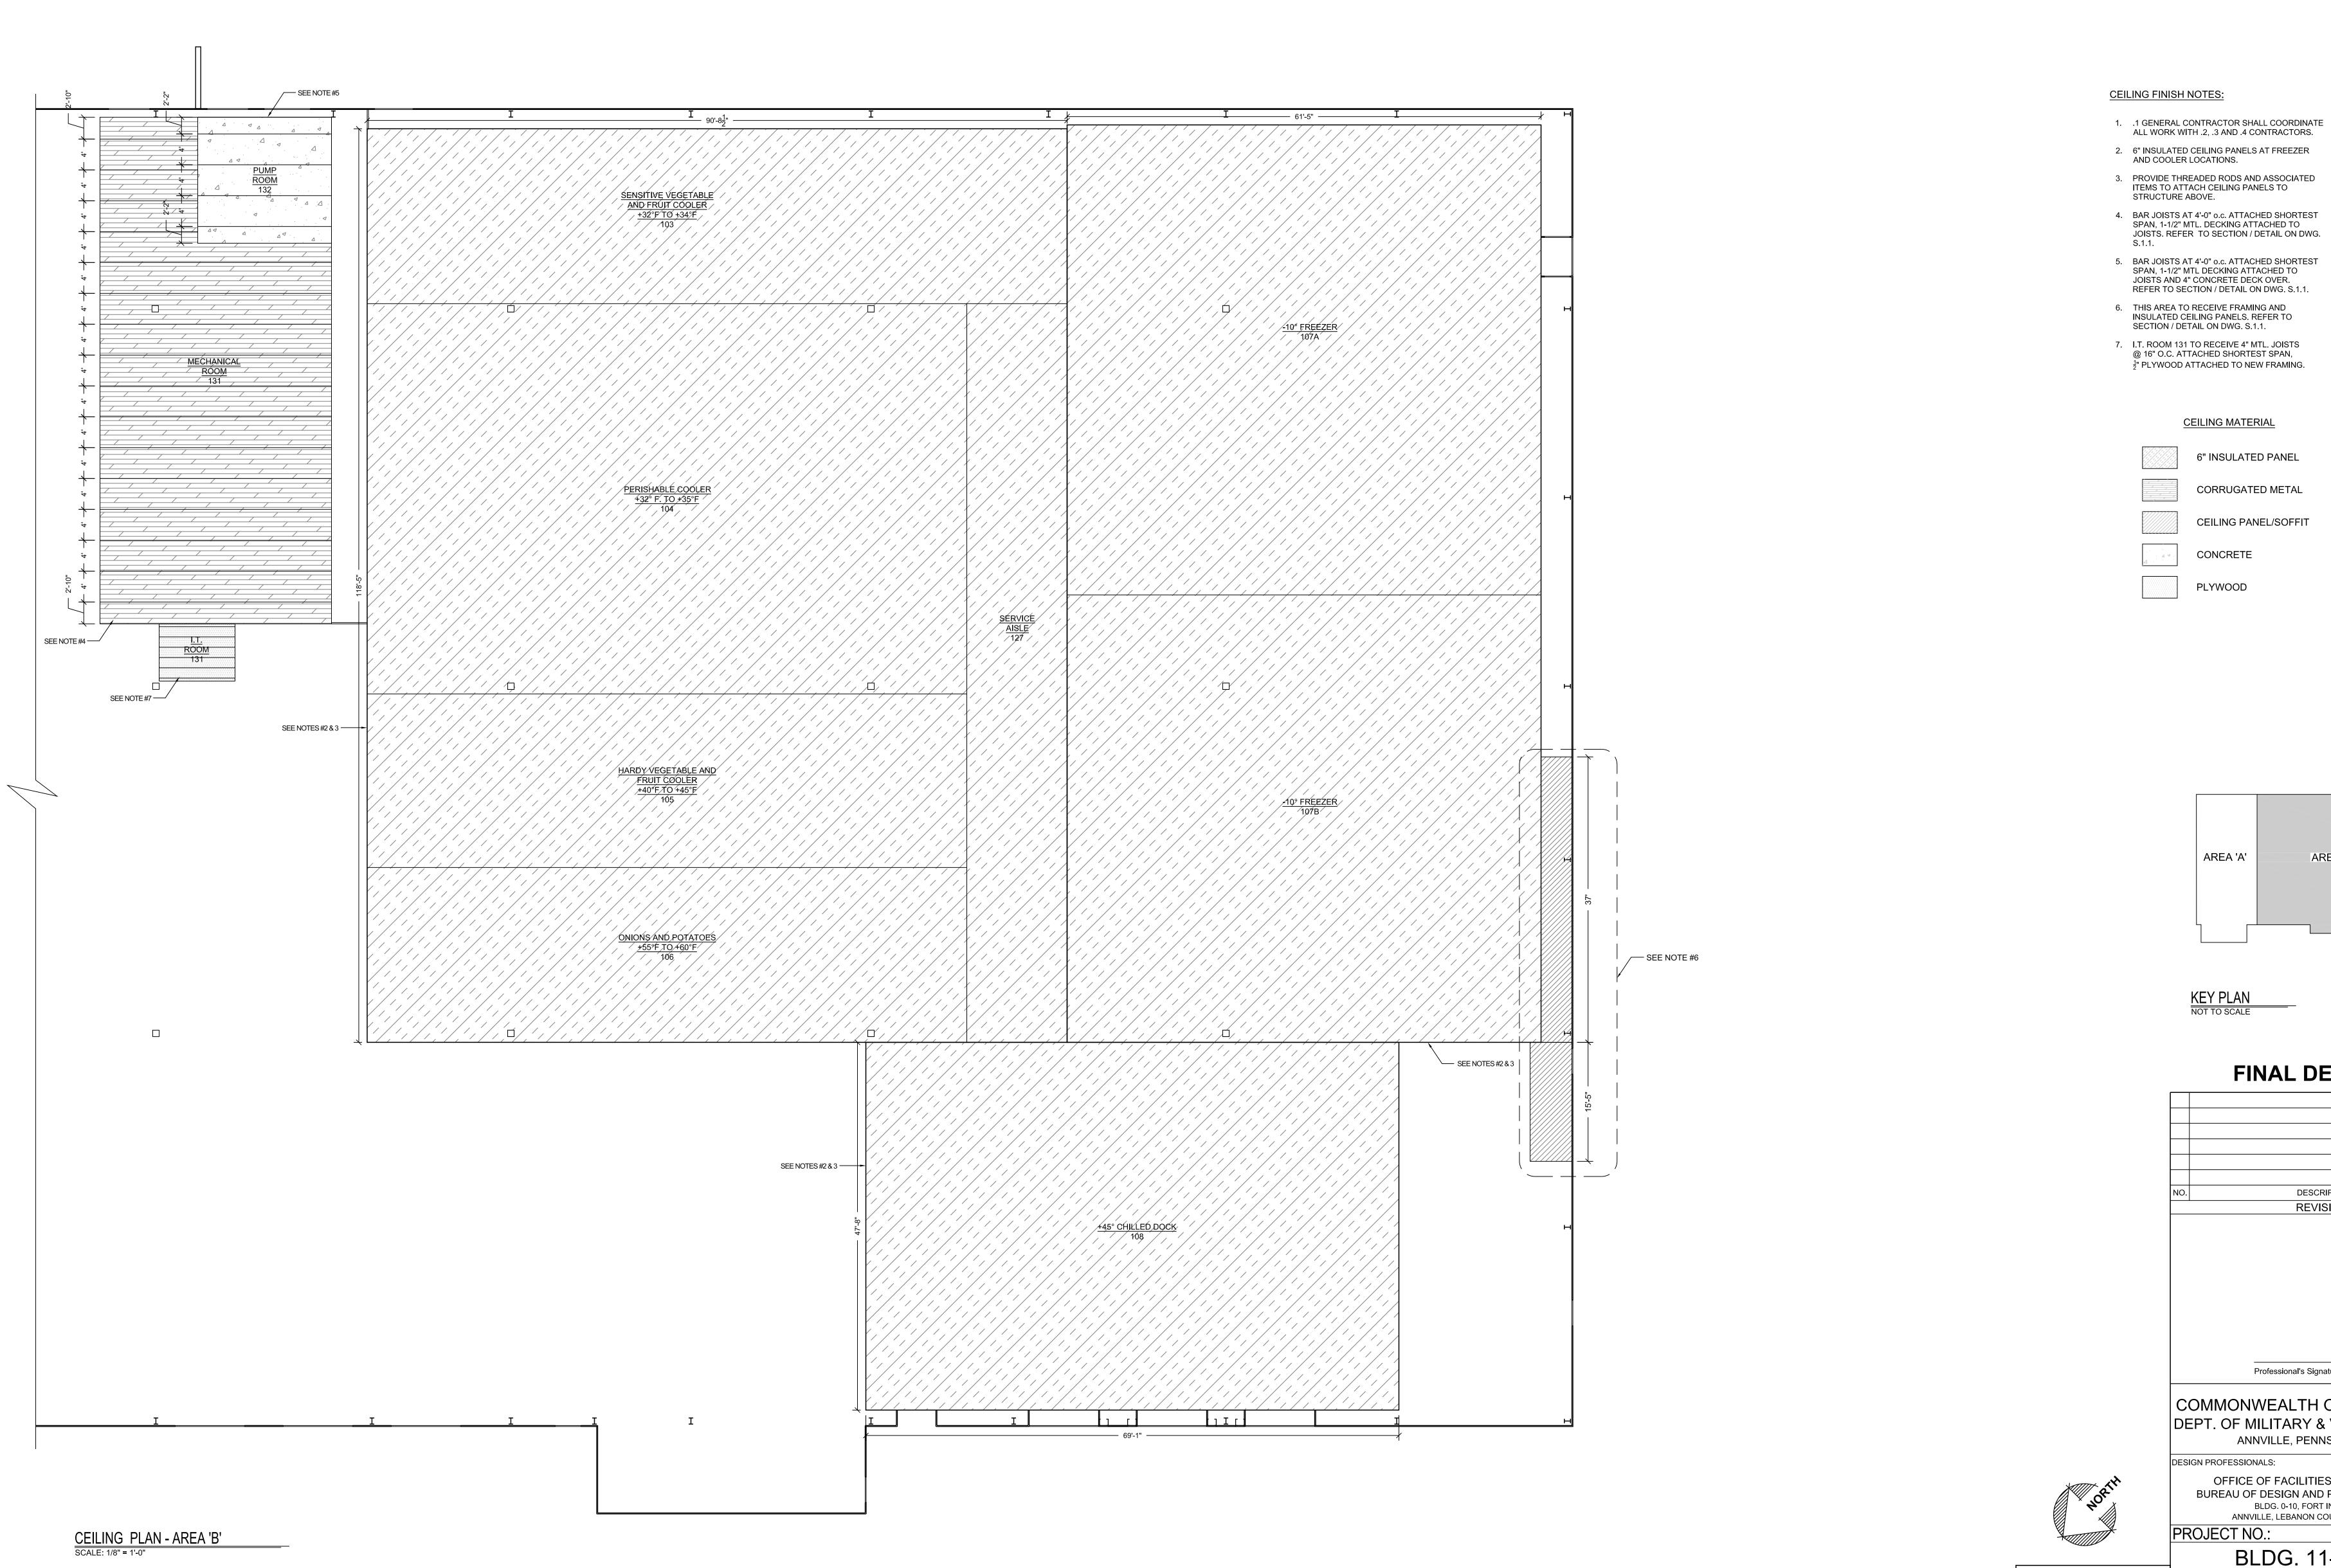



	BL
	١E
AREA 11, L	FT IN EBAI


BAR IS ONE (1) INCH LONG ON ORIGINAL DRAWING:	LEE			
0 IF BAR IS NOT ONE (1) INCH LONG, ADJUST SCALE ACCORDINGLY	CEILI			
CONTRACTOR SHALL FIELD VERIFY ALL DIMENSIONS. VARIANCE FROM CONTRACT	DRAWN BY M. MORRIS			
DOCUMENTS NOT PERMITTED WITHOUT BUREAU OF ENGINEERING	CHECKED BY			


VERIFY SCALE

AREA 'B' FINAL DESIGN DATE DESCRIPTION REVISIONS Professional's Signature Date COMMONWEALTH OF PENNSYLVANIA DEPT. OF MILITARY & VETERAN'S AFFAIRS ANNVILLE, PENNSYLVANIA 17003 OFFICE OF FACILITIES AND ENGINEERING BUREAU OF DESIGN AND PROJECT MANAGEMENT BLDG. 0-10, FORT INDIANTOWN GAP ANNVILLE, LEBANON COUNTY, PENNSYLVANIA 420591(88821) LDG. 11-89 TISA ERGY UPGRADES INDIANTOWN GAP, EAST HANOVER TWP ANON COUNTY, PENNSYLVANIA ING PLAN - AREA 'B' DATE DRAWING NO. 29 APR 2024 A.1.2 SCALE AND ARCHITECTURE APPROVAL. J. NYE AS NOTED

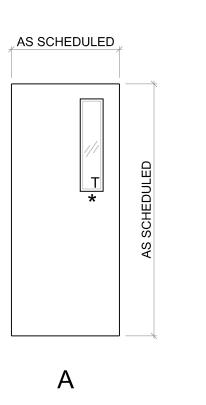

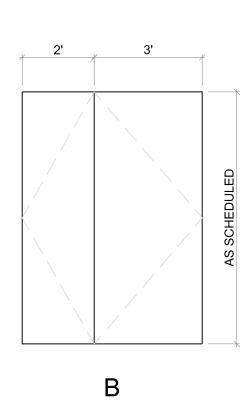

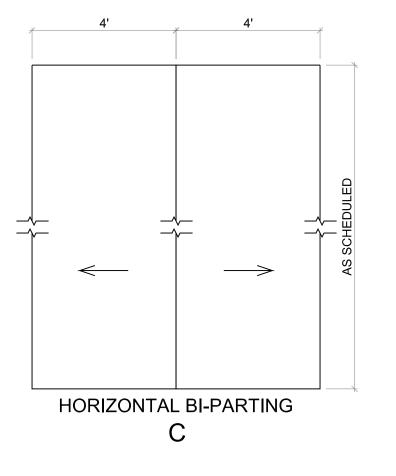

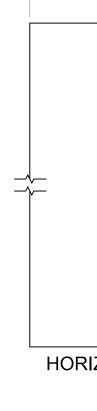

DOOR TYPES SCALE: ³/₈" = 1'-0"

DOOR AND FRAME SCHEDULE														
DOOR					F	FRAME			HARDWA	ARE				
DOOR NO.		SIZ	Έ		MAT'L	TYPE	GLASS TYPE	MAT'L	TYPE	JAMB DET.	SET	KEY SIDE	CLOSER	REMARKS
	٧	N	H	T			=			DET.	NO.		SIDE	
001	2'-0"	3'-0"	7'-0"	1-3/4"	H.M.	В	\leq	H.M.	F2	С	1	EXTERIOR	RM 131	2 HR FIRE RATED
002	2'-0"	3'-0"	7'-0"	1-3/4"	H.M.	В		H.M.	F2	D	1	EXTERIOR	RM 132	2 HR FIRE RATED
003	2'-0"	3'-0"	7'-0"	1-3/4"	H.M.	В		H.M.	F2	В	1	AREA 'A'	RM 131	2 HR FIRE RATED
004	3'-	-0"	7'-0"	1-3/4"	H.M.	A		H.M.	F1	-	4			
005	9'-	-0"	9'-0"	1-5/8"	STEEL	E	DBL INSUL	STEEL	F4	E	3		\mathbb{N}	VERTICAL LIFT
006	9'.	-0"	9'-0"	1-5/8"	STEEL	E	DBL INSUL	STEEL	F4	E	3			VERTICAL LIFT
007	9'.	-0"	9'-0"	1-5/8"	STEEL	E	DBL INSUL	STEEL	F4	E	3		$ \ \ \ \ \ \ \ \ \ \ \ \ \ $	VERTICAL LIFT
008	3'-	-0"	7'-0"	1-3/4"	H.M.	A		H.M.	F1	A	2	AREA 'A'		
009	3'	-0"	7'-0"	1-3/4"	H.M.	A		H.M.	F1	A	2	AREA 'A'		
010	3'	-0"	7'-0"	1-3/4"	H.M.	A*	6x30	H.M.	F1	A	2	AREA 'A'	RM 108	INSULATED CORE
NOTE:														

NOTE: 1. DOORS 005, 006, 007: PROVIDE DOCK SEAL WITH HEAD PAD.

					C O O	LER	А	N D F	R	ΕE	ΕΖΕ	R D O	OR SCHEDULE	
DOOR		FRAME HARDWARE				RDWARE								
DOOR NO.	M	SIZ /	E H	Т	MAT'L	FINISH	TYPE	MAT'L	JAMB DET.	-	HEATER CABLE	OPERATION	REMARKS	DOOR NO.
100	3'-	0"	7'-0"	4"	MTL CLAD	GALV	Α	GALV STL	G		YES	MANUAL	PROVIDE PANIC BAR HARDWARE	100
101	3'-	0"	7'-0"	4"	MTL CLAD	GALV	A	GALV STL	G		YES	MANUAL	PROVIDE PANIC BAR HARDWARE, NO EXTERIOR HARDWARE	101
102	3'-	0"	7'-0"	4"	MTL CLAD	GALV	A	GALV STL	G		YES	MANUAL	PROVIDE PANIC BAR HARDWARE	102
103	4'-0"	4'-0"	12'-0"	4"	MTL CLAD	GALV	С	GALV STL	F		YES	AUTOMATIC		103
104	4'-0"	4'-0"	12'-0"	4"	MTL CLAD	GALV	С	GALV STL	F			AUTOMATIC		104
105	NOTI	JSED												105
106	4'-0"	4'-0"	12'-0"	4"	MTL CLAD	GALV	С	GALV STL	F			AUTOMATIC	BASE BID 3	106
107	4'-0"	4'-0"	12'-0"	4"	MTL CLAD	GALV	С	GALV STL	F			AUTOMATIC	BASE BID 3	107
108	4'-0"	4'-0"	12'-0"	4"	MTL CLAD	GALV	С	GALV STL	F			AUTOMATIC	BASE BID 3	108
109	8'-	0"	12'-0"	4"	MTL CLAD	GALV	D	GALV STL	F		YES	AUTOMATIC		109
110	4'-0"	4'-0"	12'-0"	4"	MTL CLAD	GALV	С	GALV STL	F		YES	AUTOMATIC		110

<u>HARDWARE SET #1</u> HINGES: HEAVY DUTY, 5 KNUCKLE, FULL MORTISE OPENING DEVICE: ACTIVE LEAF - LEVER HANDLE w/ KEYED CORE

INACTIVE LEAF - NONE

LOCKING DEVICE: ACTIVE LEAF - CYLINDRICAL LOCK INACTIVE LEAF - MANUAL FLUSH BOLTS, TOP AND BOTTOM

EXITING DEVICE: ACTIVE LEAF - TOUCH BAR INACTIVE LEAF - NONE

CLOSER: ACTIVE LEAF - TOP SURFACE MOUNT ON DOOR w/ 120° PARALLEL ARM INACTIVE LEAF - NONE

<u>HARDWARE SET #2</u> HINGES: 5 KNUCKLE, FULL MORTISE

OPENING DEVICE: LEVER HANDLE w/ KEYED CORE

LOCKING DEVICE: CYLINDRICAL LOCK

EXITING DEVICE: LEVER HANDLE CLOSER: TOP SURFACE MOUNT ON DOOR w/ 120° PARALLEL ARM

HARDWARE SET #3 MANUFACTURER'S STANDARD HARDWARE

HARDWARE SET #4

HINGES: 5 KNUCKLE, FULL MORTISE

OPENING DEVICE: LEVER HANDLE

LOCKING DEVICE: NONE EXITING DEVICE: LEVER HANDLE

CLOSER: TOP SURFACE MOUNT ON DOOR w/ 120° PARALLEL ARM

NOTES:

1. ALL LOCK CYLINDER SHALL BE 'BEST ACCESS SYSTEMS CORE.' NO SUBSTITUTION.


2. ALL EXTERIOR HARDWARE SETS SHOULD ALSO INCLUDE

WEATHERSTRIPPING, DOOR SWEEP (NEOPRENE), AND A THRESHOLD. 3. PROVIDE KICKPLATES ON ALL PERSONNEL DOORS.

	LINTEL SCHEDULE						
MARK	LOCATION	SIZE	M.O.	DETAIL	REMARKS		
L1	DOORS 001 & 003	(2) 4" x 8" PRECAST CONCRETE EA. w/ (1)#4 T&B	6'-4" MAX.		8" CMU WALLS		
L2	DOOR 002	8x10, ³ / ₈ " x 7 ¹ / ₂ " STEEL PLATE	6'-4" MAX.		10" CONC. WALL		
NOTES							


1. ALL LINTELS SHALL BEAR 8" MINIMUM EACH SIDE OF MASONRY OPENING. 2. PROVIDE (2) #5 @ LINTEL BRG. FOR JAMB REINFORCEMENT, TYP.


3. ALL STEEL LINTELS SHALL BE SHOP PRIMED & FIELD PAINTED.

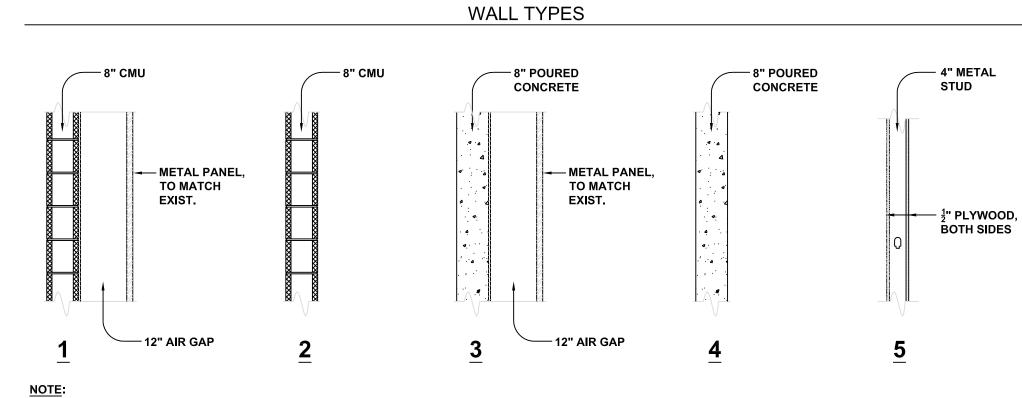



WALL TYPES 1 & 3 - PROVIDE FRAMING, METAL PANELS AND TRIM TO ENCLOSE SPACE AT DOOR AND EXPLOSION RELIEF PANEL LOCATIONS.

					ROOM F	INISH SO	CHEDULE				
RM. NO.	ROOM NAME	FLOOR	BASE		V	VALLS		CEILING		REMARKS	RM
NO.		MATERIAL	MATERIAL	- WALL 'A'	WALL 'B'	WALL 'C'	WALL 'D'	MATERIAL	HGT.	REMARKS	RM. NO
131 I.T. R	ROOM	EXIST.		PAINT PLYWOOD	9'-0"+/-		131				
132 MEC	HANICAL ROOM	EXIST.	$\left \right\rangle$	PAINT C.M.U.	PAINT C.M.U.	PAINT C.M.U.	PAINT C.M.U.	METAL DECK	12'-0"+/-		132
133 PUM	P ROOM	EXIST.		CONCRETE	CONCRETE	CONCRETE	CONCRETE	METAL DECK	12-0"+/-		133

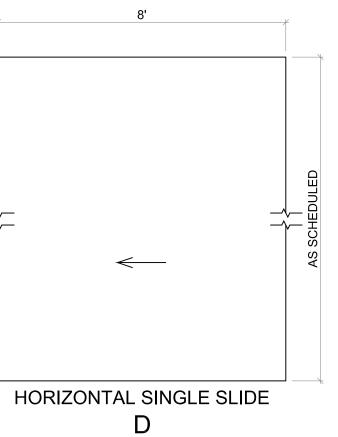

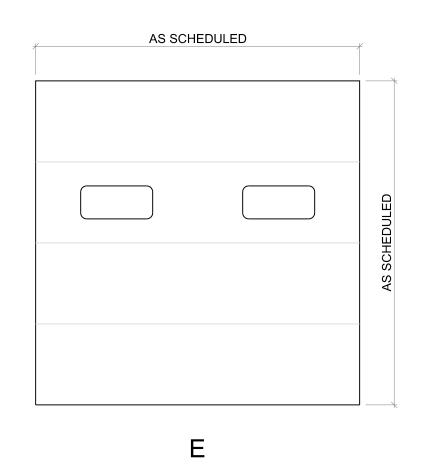


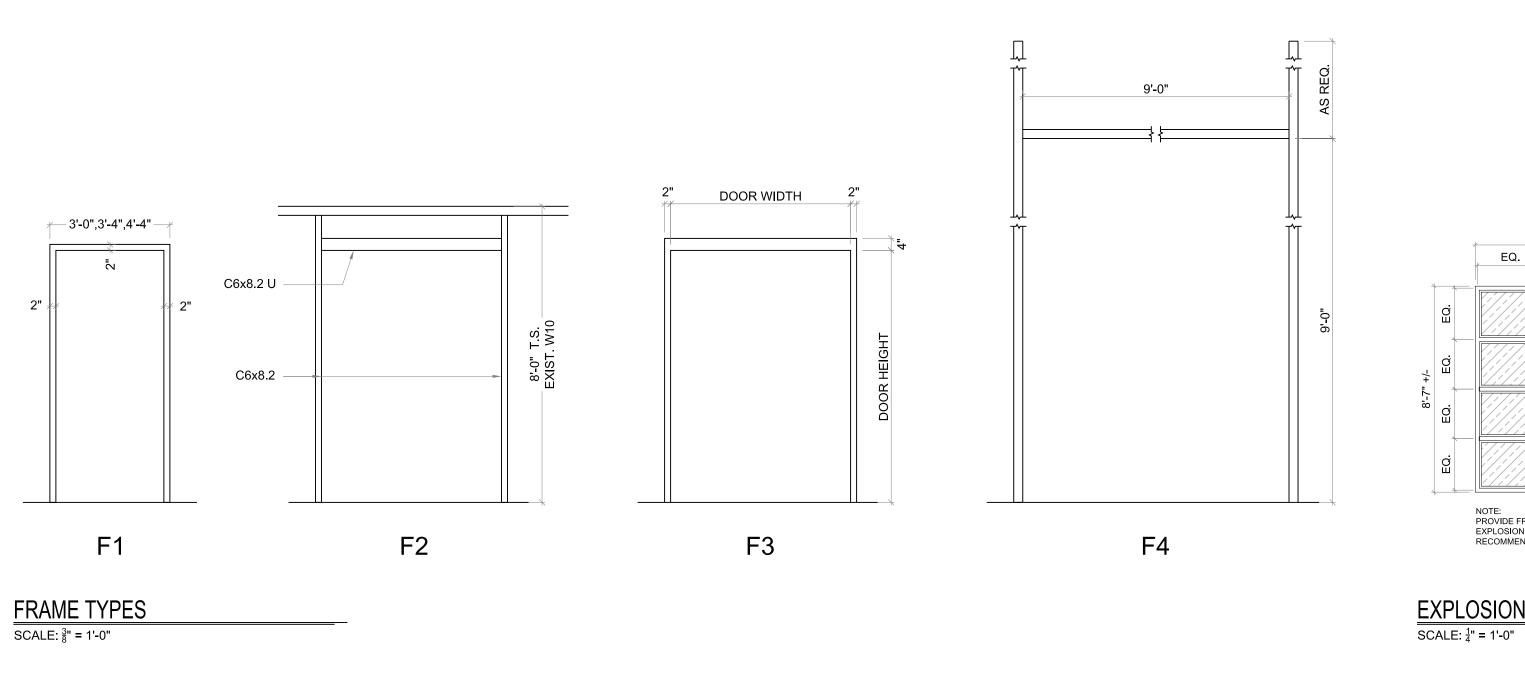

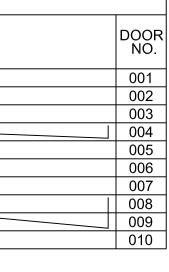


	007		
	008		
	009		
	010		
	•	,	
KS			DOC NC
			100
, NO EXTERIO	OR HAR	DWARE	10
			102
			103

<u>TYPE 'A'</u>		
Z"	VARIES	7-5/8"

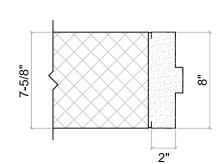


NOTE: GROUT FILL FRAMES

TYPE 'B'

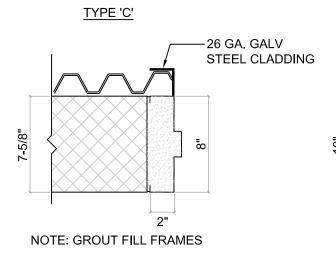


JAMB TYPES SCALE: 1¹/₂" = 1'-0"




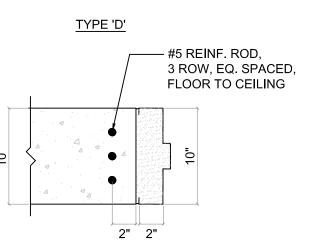



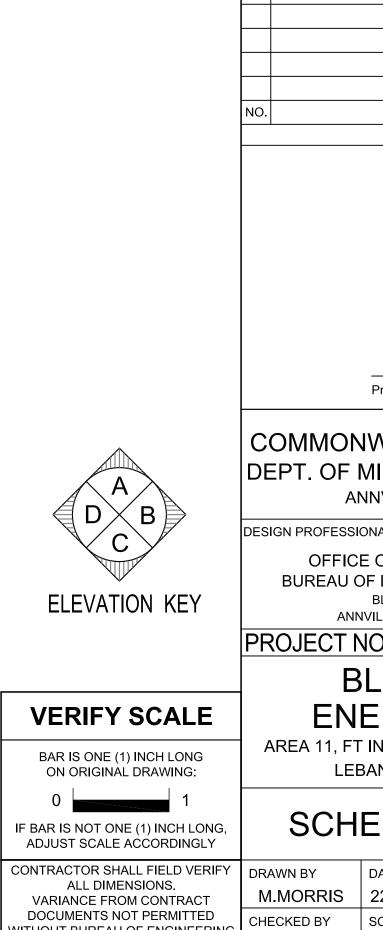


J. NYE

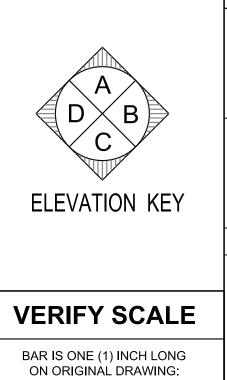

WITHOUT BUREAU OF ENGINEERING

AND ARCHITECTURE APPROVAL.

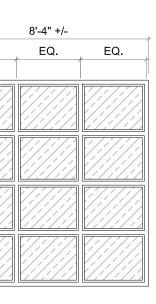



NOTE: PROVIDE FRAMING AND ATTACHMENTS PER EXPLOSION RELIEF PANEL MANUFACTURER'S RECOMMENDATIONS.


EXPLOSION RELIEF PANELS

NAL DE	SIGN	
DESCRI	PTION	DATE
REVIS		
Professional's Signa	ture Date	
IILITARY &	OF PENNSYLV VETERAN'S AF SYLVANIA 17003	
NALS:	S AND ENGINEERIN	G
DESIGN AND BLDG. 0-10, FORT	PROJECT MANAGEN	
D.:	420591(888	321)
_DG. 11	-89 TISA	
NDIANTOWN (PGRADES GAP, EAST HANOVE (, PENNSYLVANIA	
EDULES	8 & DETAIL	S
DATE 22 NOV 2023	DRAWING NO.	
SCALE AS NOTED	A.2.1	



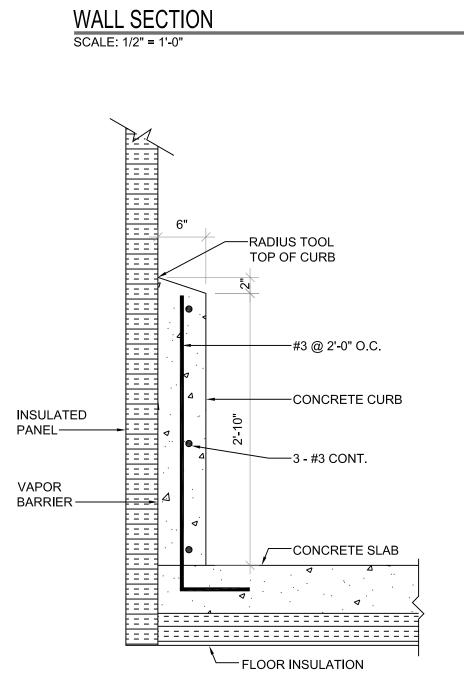


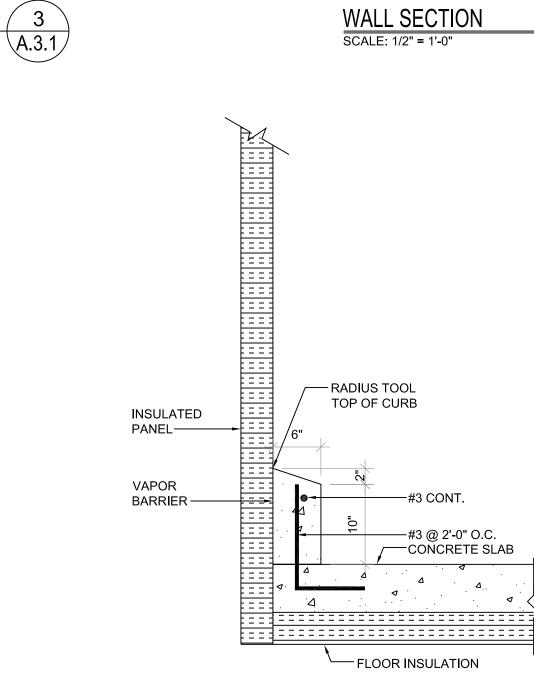

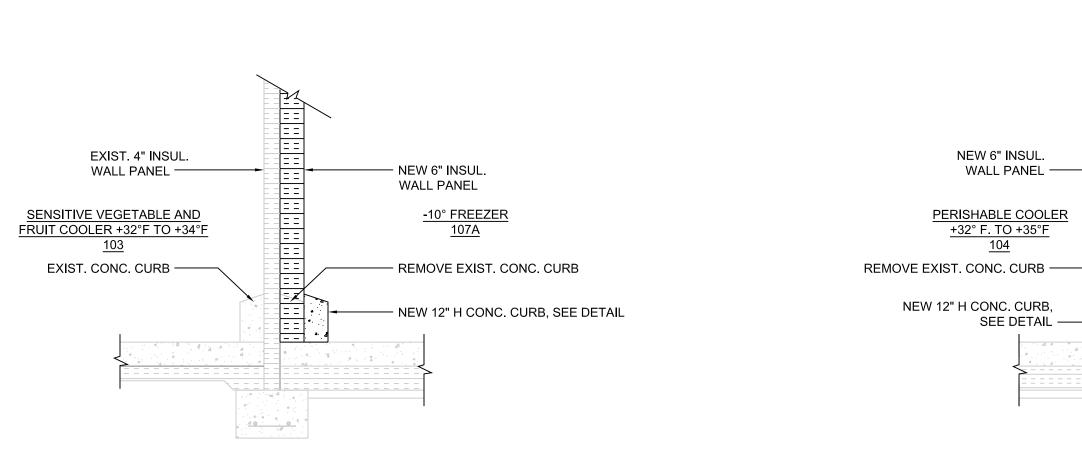







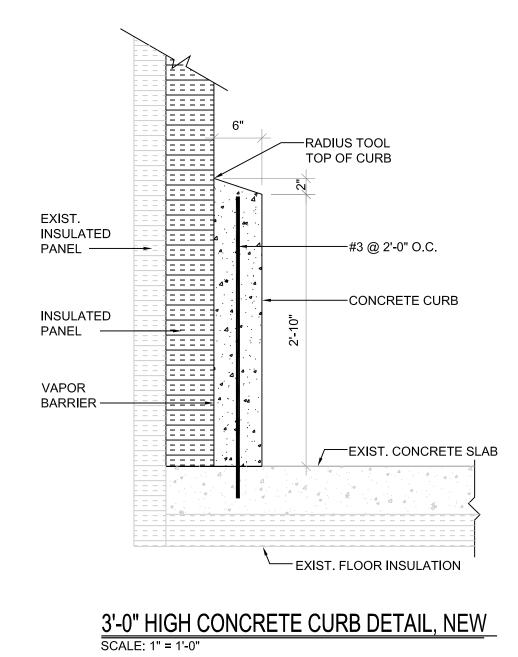

4 (A.3.1)

EXIST. INSULATED PANEL VAPOR BARRIER —— +===> -CONCRET ------#3 @ 2'-0" (_____EXIST. COI ____ · · 4 / 4

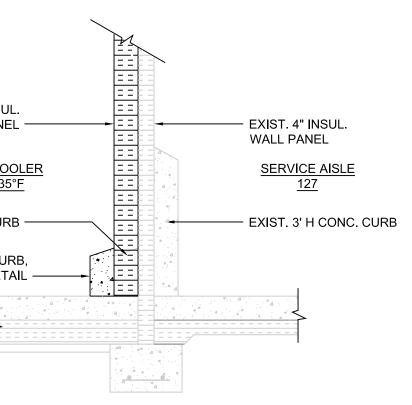

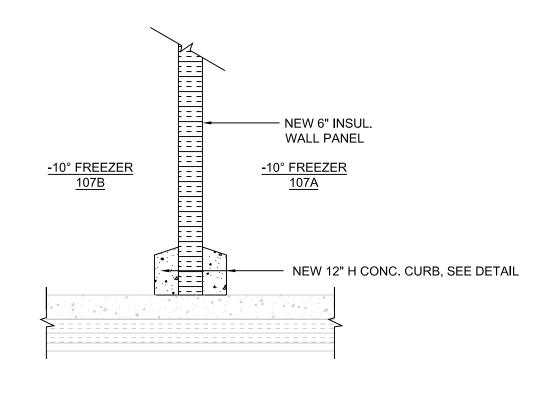

WALL SECTION SCALE: 1/2" = 1'-0"

NOT USED \A.3.1/

ULATED VULATED VEL VEL VEL VEL VEL VEL VEL VEL	
ST. ULATED VEL VEL VEL VEL VEL VEL VEL VEL	
ST. ULATED VEL POR RRIER CONCRETE CURB COMMO DEPT. OL DESIGN PROFE OFF BUREAU POR RRIER COMMO DEPT. OL DESIGN PROFE COMMO DEPT. OL DESIGN PROFE OFF BUREAU PROJECT	Prof
VLATED VLATED VEL POR RRIER CONCRETE CURB CONCRETE CURB CONCRETE CURB	F MIL ANNVI
	FICE OF U OF DI BLD ANNVILLE
	BLE NEF
EXIST. CONCRETE SLAB BAR IS ONE (1) INCH LONG	
0 In 1 IF BAR IS NOT ONE (1) INCH LONG, ADJUST SCALE ACCORDINGLY	
12" HIGH CONCRETE CURB DETAIL, NEW DRAWN BY SCALE: 1" = 1'-0" M.MORRIS SCALE: 1" = 1'-0" D.CUMENTS NOT PERMITTED ADD ARCHITECTURE APPROVAL. J. NYE	DAT S 29 SCA


______ 6" INSUL. WALL PANEL ______ RADIUS TOOL TOP OF CURB

—— #6 REBAR

#4 STIRRUPS EVERY 6"

- CONC. CURB BEYOND


FINAL DESIGN	I
DESCRIPTION	DATE
Professional's Signature Date	
ONWEALTH OF PENNSYLY OF MILITARY & VETERAN'S AF ANNVILLE, PENNSYLVANIA 17003	
FESSIONALS: FFICE OF FACILITIES AND ENGINEERING AU OF DESIGN AND PROJECT MANAGEN BLDG. 0-10, FORT INDIANTOWN GAP ANNVILLE, LEBANON COUNTY, PENNSYLVANIA	
CT NO.: 420591(888	321)
BLDG. 11-89 TISA ENERGY UPGRADES 1, FT INDIANTOWN GAP, EAST HANOVE	
LEBANON COUNTY, PENNSYLVANIA	
DETAILS	
DATE DRAWING NO. 29 APR 2024 C SCALE AS NOTED DRAWING NO.	
I I	

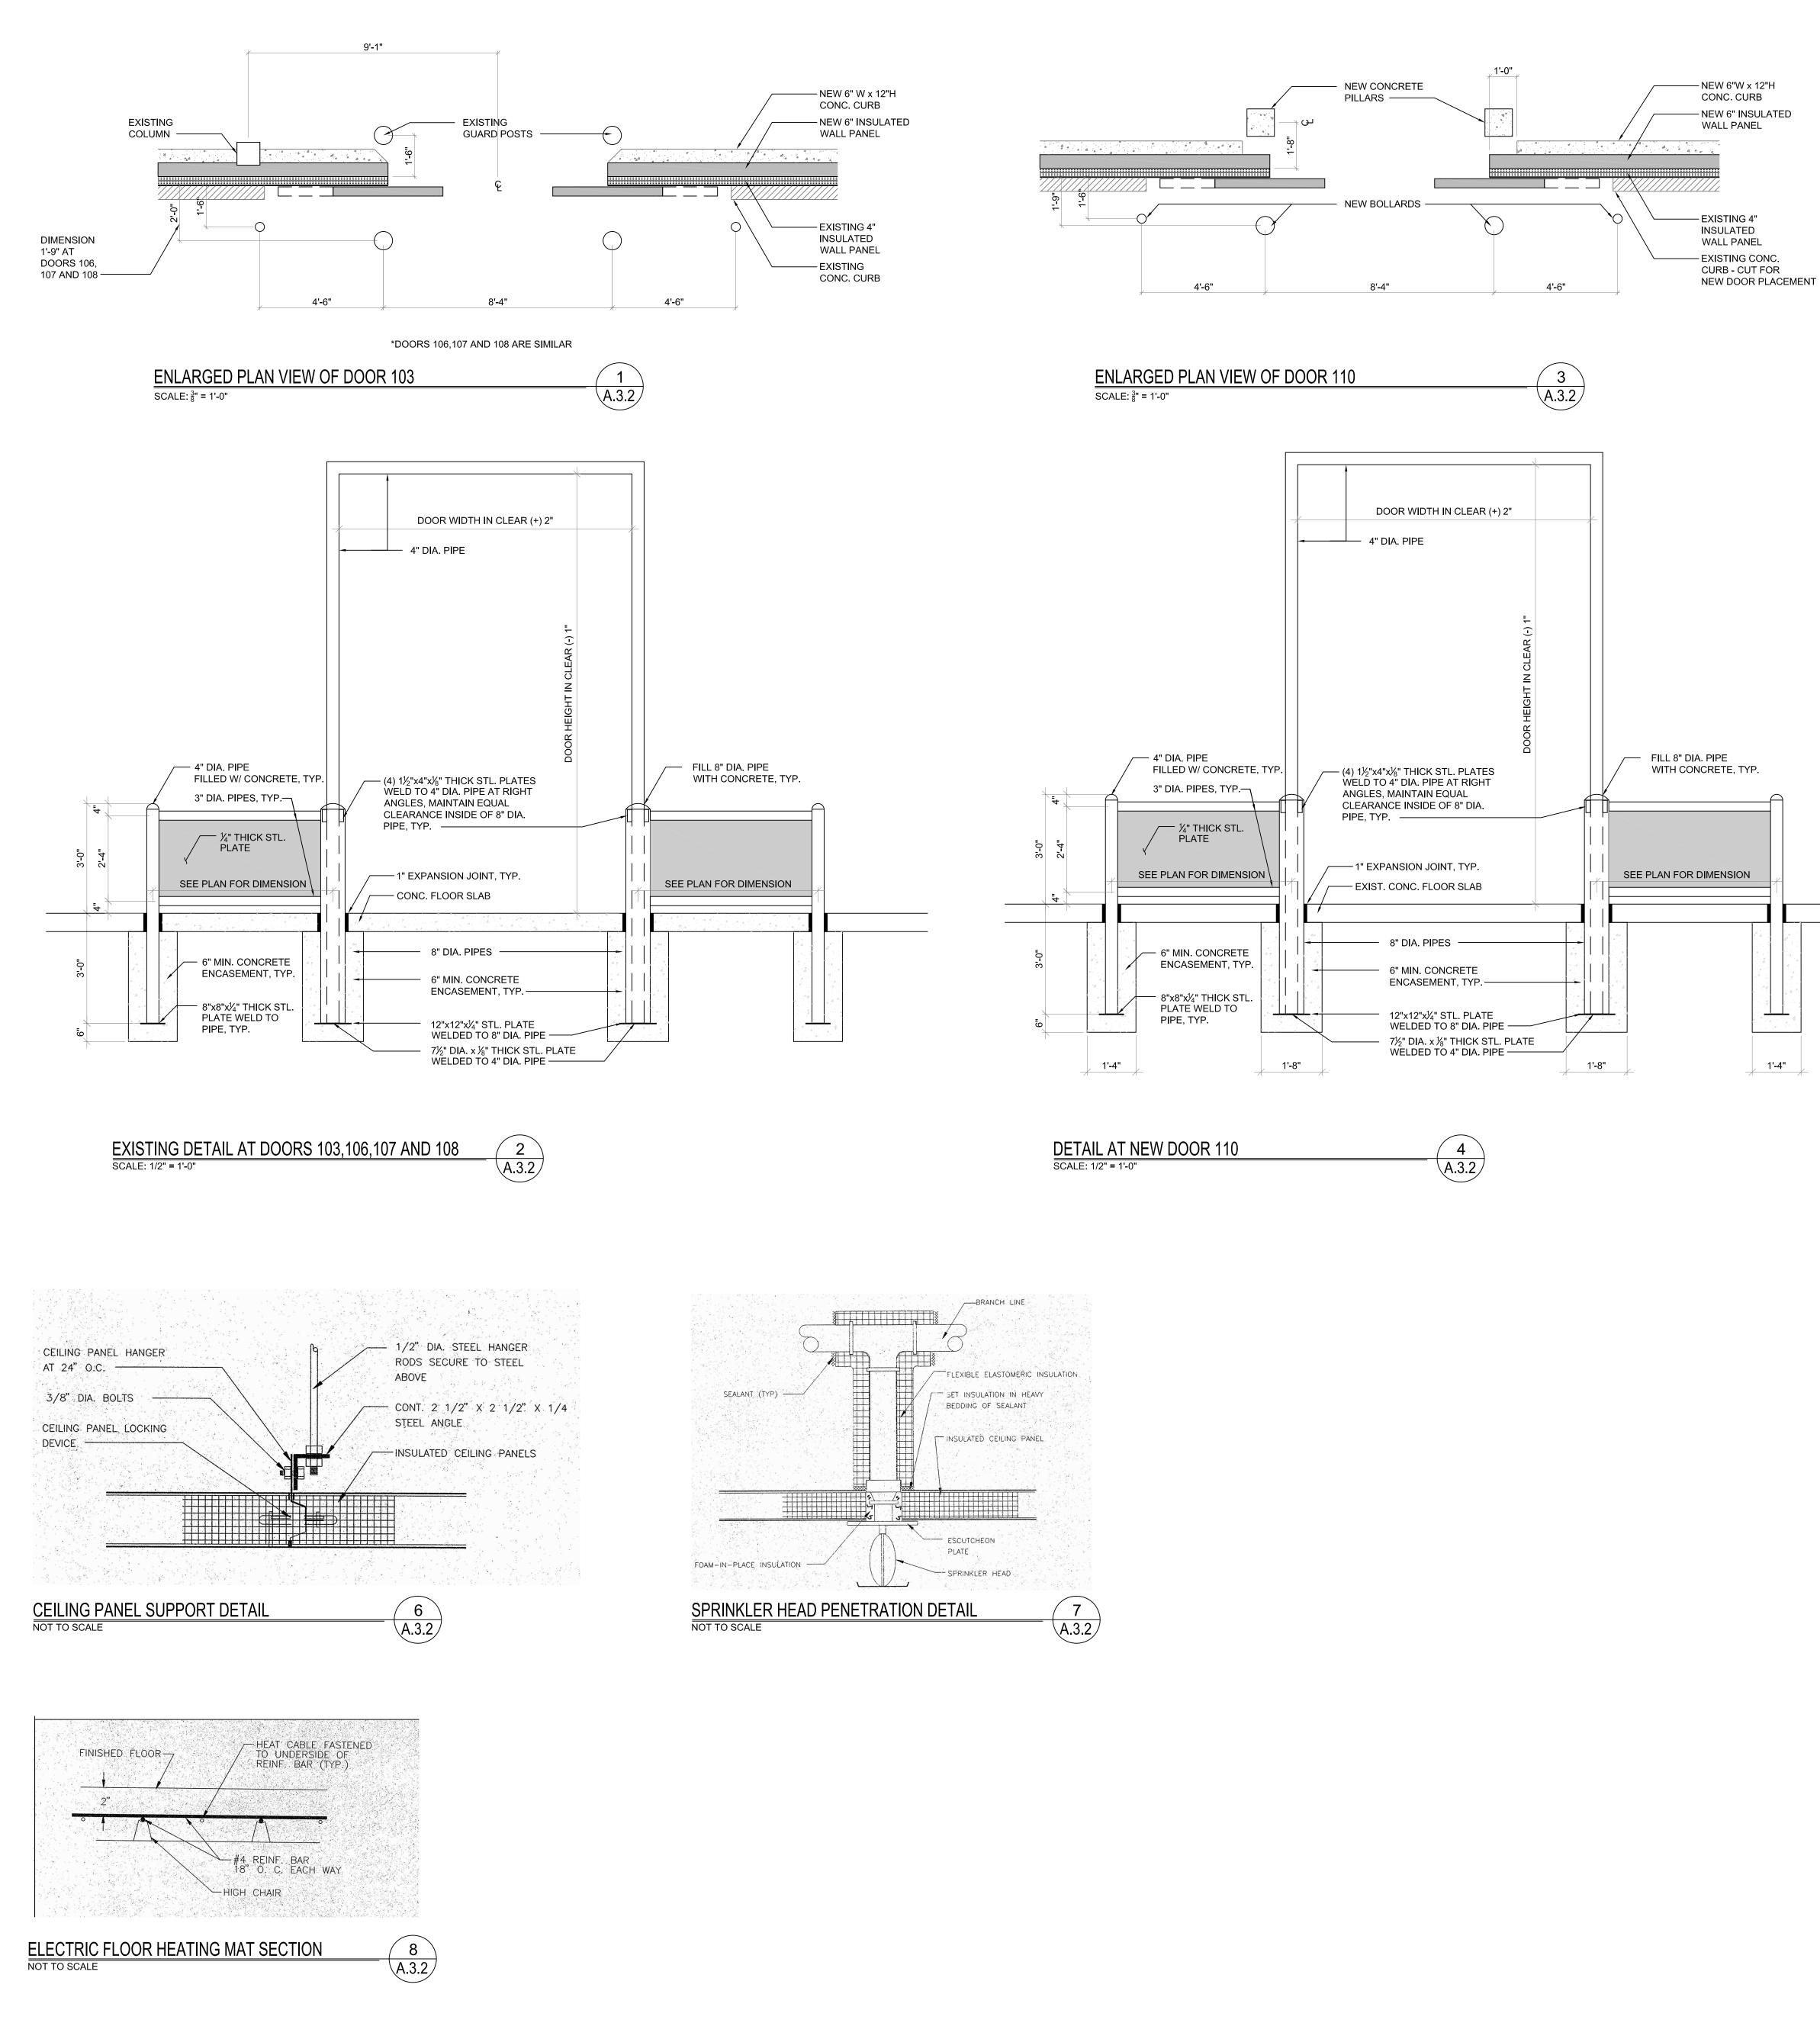


– NEW 6"W x 12"H — NEW 6" INSULATED


- EXISTING CONC.



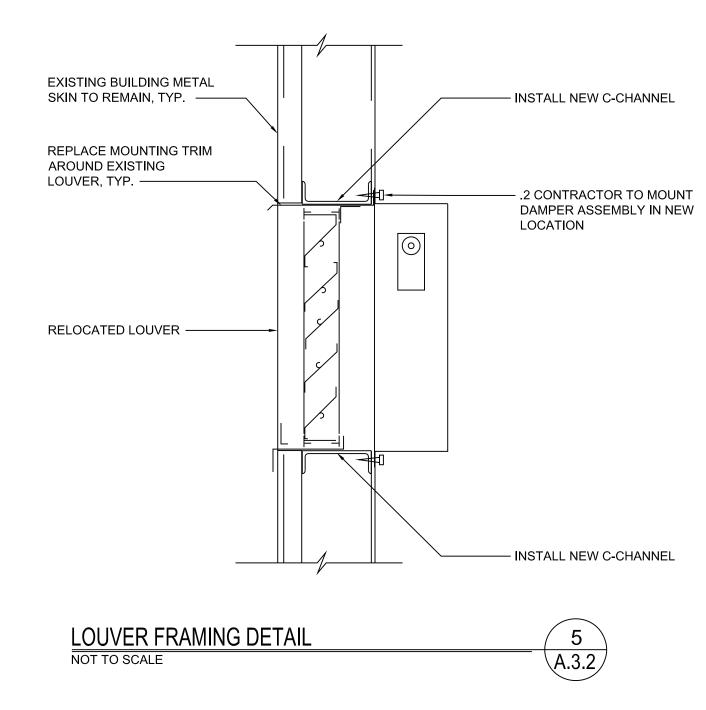

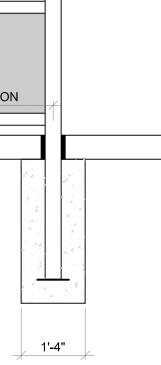


FIN

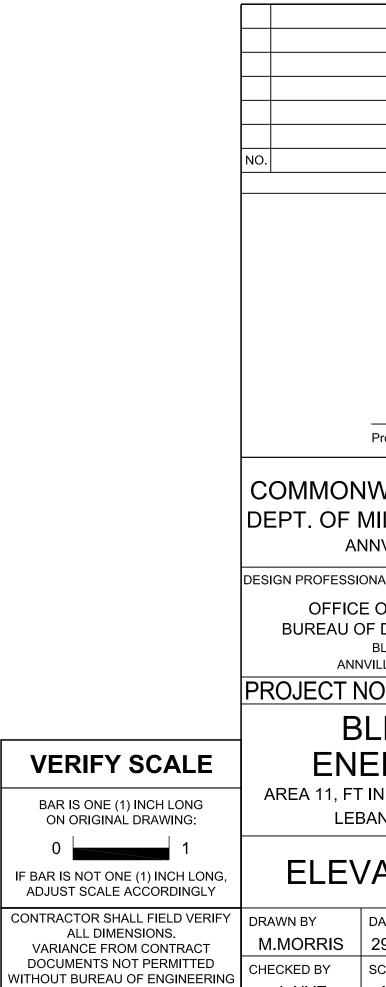


J. NYE

AND ARCHITECTURE APPROVAL.

NAL DESIGN	
DESCRIPTION	DATE
Professional's Signature Date	
WEALTH OF PENNSYL ILITARY & VETERAN'S AI IVILLE, PENNSYLVANIA 17003	
IALS: OF FACILITIES AND ENGINEERIN DESIGN AND PROJECT MANAGEN BLDG. 0-10, FORT INDIANTOWN GAP ILLE, LEBANON COUNTY, PENNSYLVANIA O.: 420591(888)	MENT
DG. 11-89 TISA RGY UPGRADES NDIANTOWN GAP, EAST HANOVE NON COUNTY, PENNSYLVANIA	
ATIONS & DETAI	LS
DATE DRAWING NO. 29 APR 2024 SCALE AS NOTED	

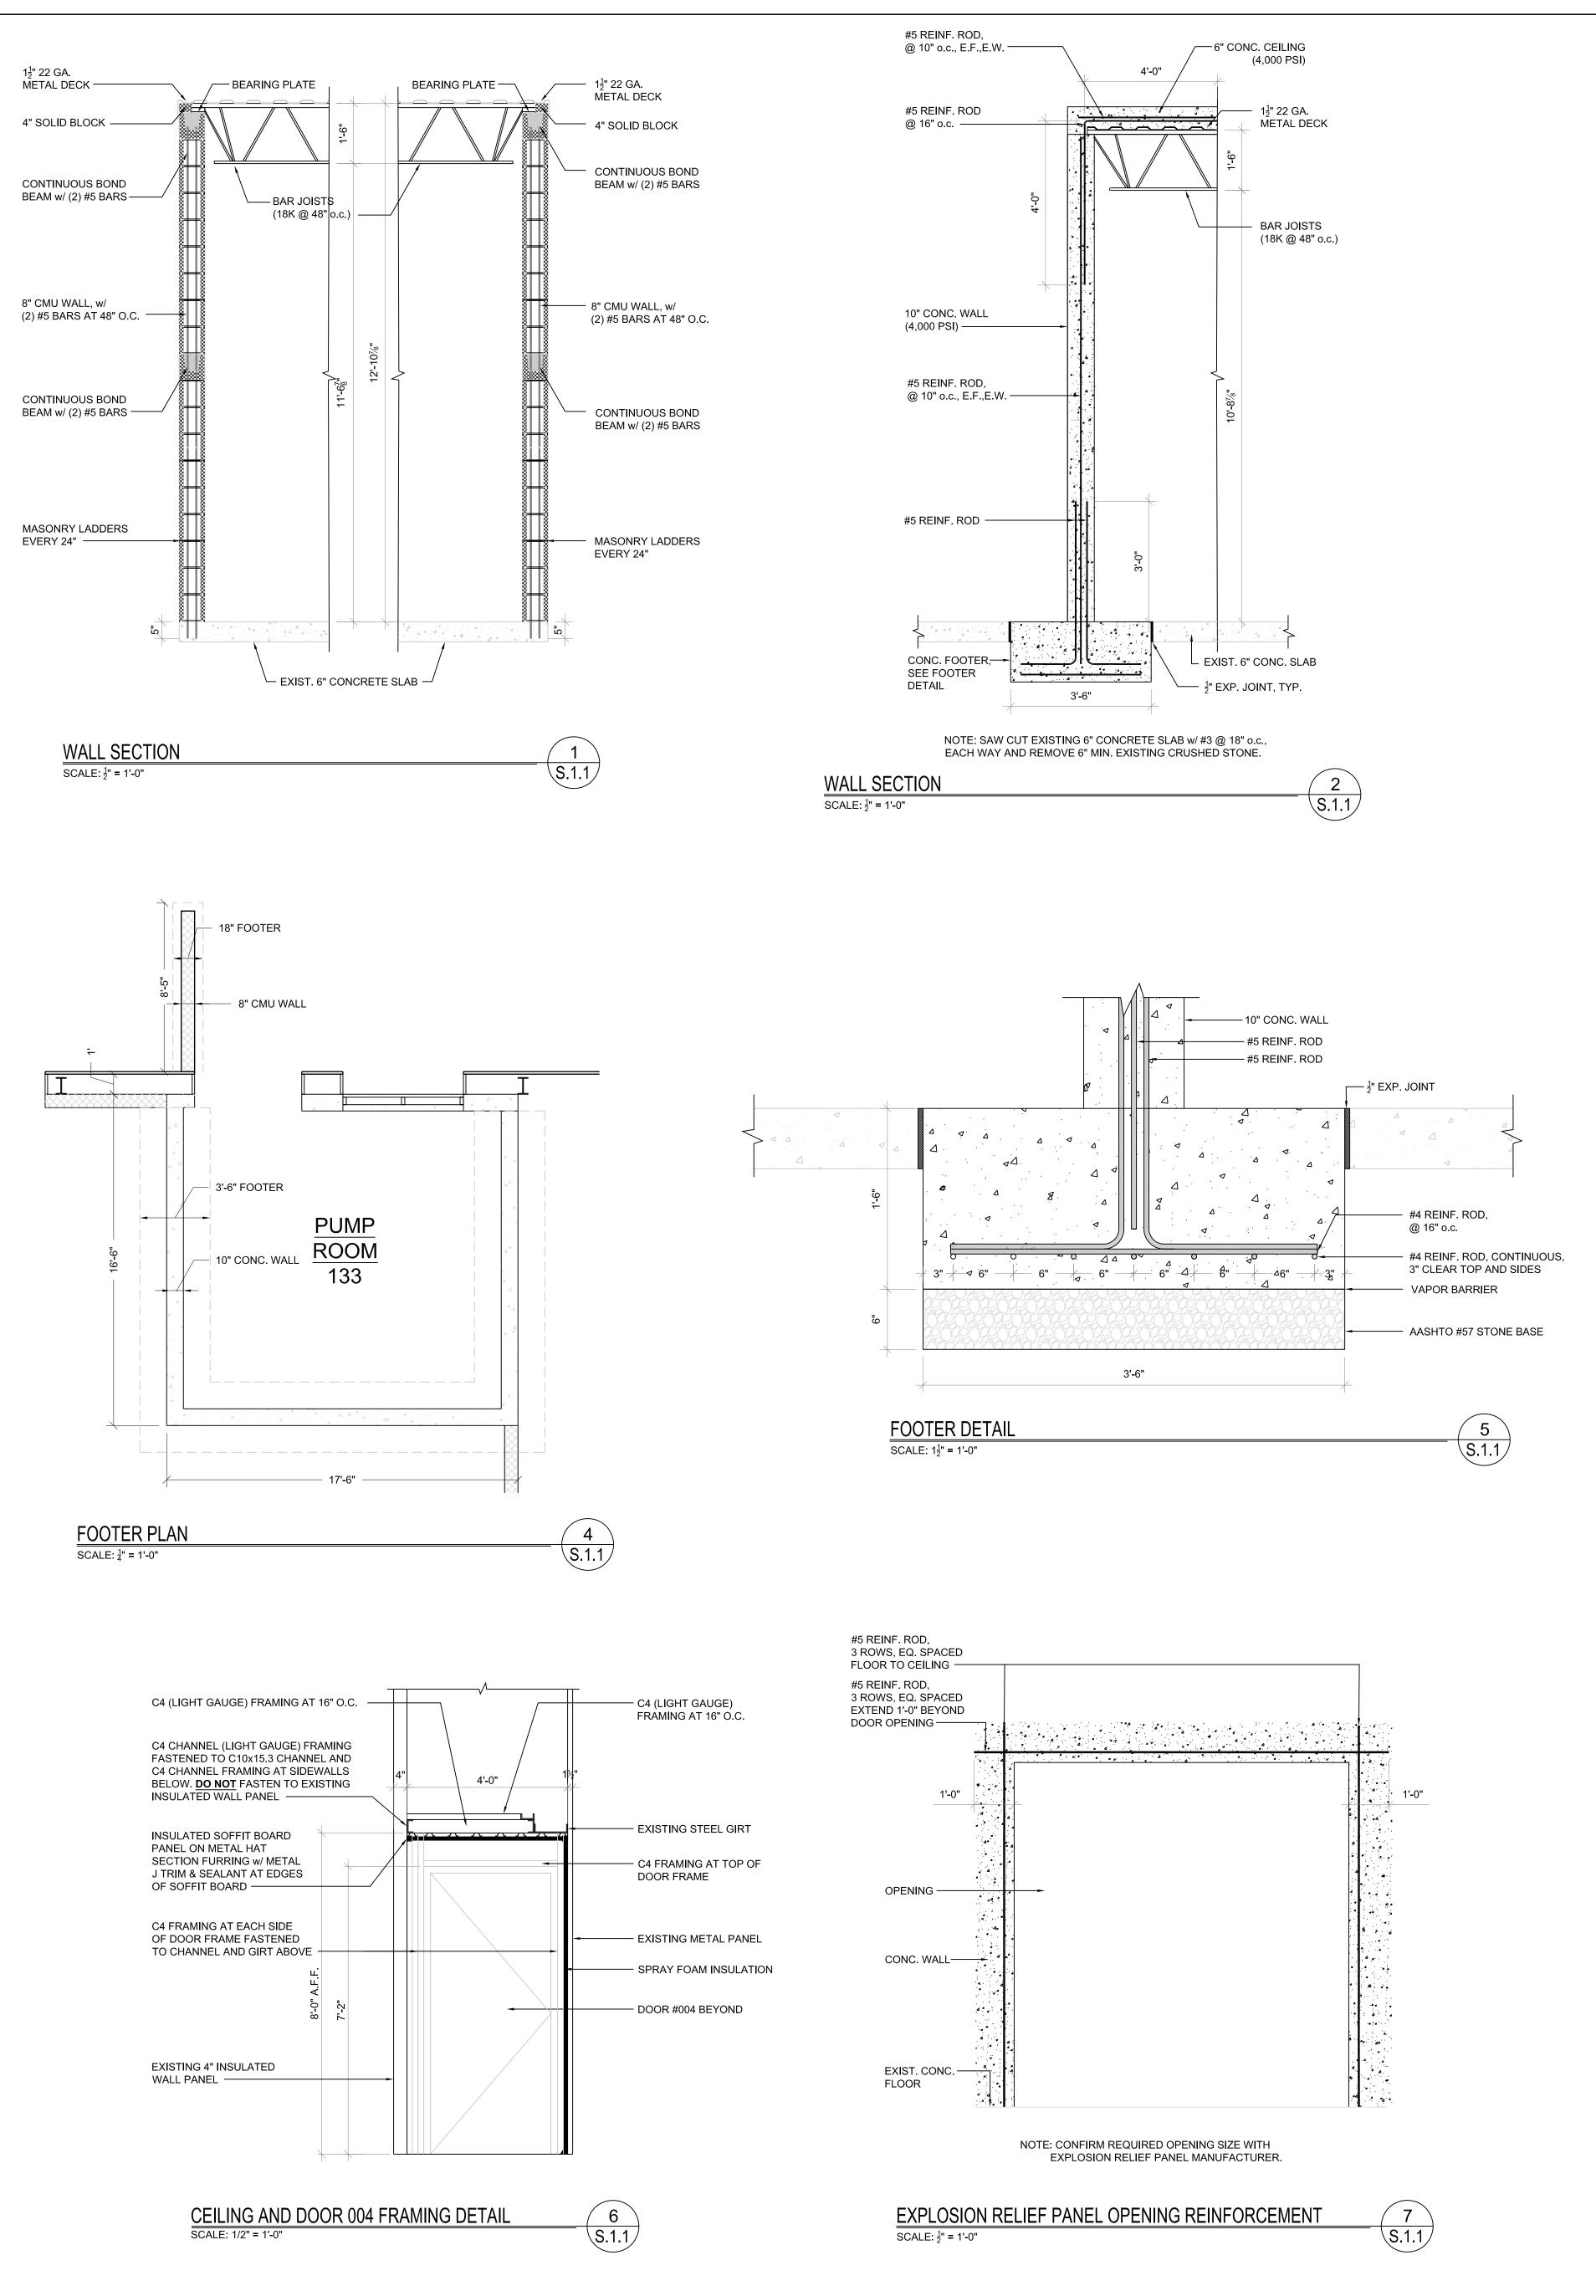

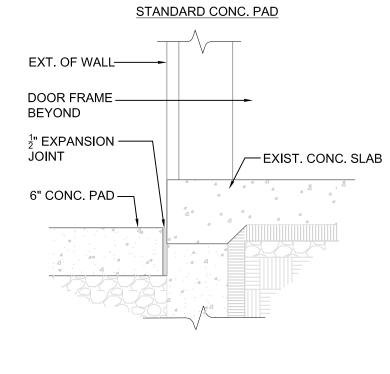


8

S.1.1

STANDARD CONC. PAD DETAIL SCALE: 1" = 1'-0"



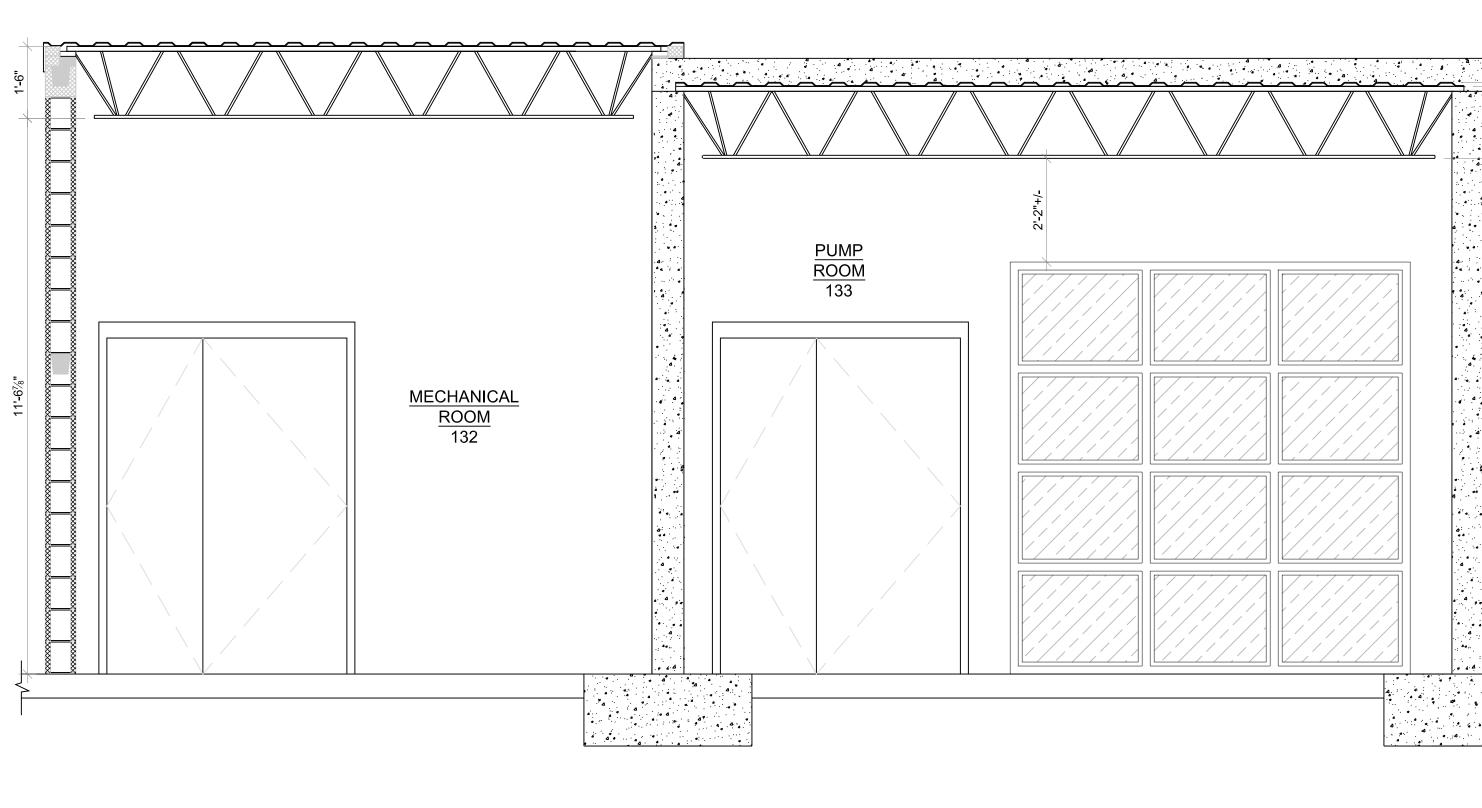

3 S.1.1/

F	

